

GENERAL NOTES

1. CONTRACTOR SHALL BE RESPONSIBLE FOR PROVIDING PERMITS, WORK, AND MATERIALS IN ACCORDANCE WITH ALL CODES, ORDINANCES AND REGULATIONS APPLICABLE AT THE PROJECT LOCATION. THESE DRAWINGS ARE INTENDED TO PROVIDE SUFFICIENT INFORMATION TO OBTAIN A BUILDING PERMIT AND CONVEY GENERAL DESIGN INTENT TO THE BUILDER. ADDITIONAL TECHNICAL ADVICE AND DETAILING MAY BE REQUIRED FOR SUCCESSFUL COMPLETION OF THIS PROJECT AND IS THE BUILDERS RESPONSIBILITY.
2. CONTRACTOR SHALL BE RESPONSIBLE FOR CHECKING CONTRACT DOCUMENTS, FIELD CONDITIONS, AND DIMENSIONS FOR ACCURACY AND CONFIRMING THAT ALL WORK IS BUILDABLE AS SHOWN BEFORE PROCEEDING WITH CONSTRUCTION. IF THERE ARE ANY DISCREPANCIES OR OMISSIONS WHICH WOULD INTERFERE WITH SATISFACTORY COMPLETION OF THE WORK, THE CONTRACTOR SHALL OBTAIN A CLARIFICATION FROM THE ARCHITECT BEFORE PROCEEDING WITH THE WORK IN QUESTION.
3. DIMENSIONS ARE NOT ADJUSTABLE, UNLESS NOTED (+/-). THE CONTRACTOR SHALL NOT SCALE DRAWINGS.
4. CONTRACTOR IS RESPONSIBLE FOR THE MEANS, METHODS AND TECHNIQUES OF CONSTRUCTION, SAFETY PRECAUTIONS IN CONNECTION WITH THE WORK, AND FOR THE ACTS OR OMISSIONS OF THE SUBCONTRACTORS.
5. INSTALL ALL MANUFACTURED ITEMS, MATERIALS, AND EQUIPMENT IN STRICT ACCORDANCE WITH MANUFACTURERS RECOMMENDED SPECIFICATIONS.
6. TYPICAL (TYP) MEANS IDENTICAL FOR ALL CONDITIONS THAT MATCH ORIGINAL CONDITION ILLUSTRATED UNLESS OTHERWISE NOTED. "SIMILAR" MEANS COMPARABLE CHARACTERISTICS OF THE CONDITION CITED. "ALIGN" MEANS NOTED SEPARATE COMPONENTS OF CONSTRUCTION, (FOR EXAMPLE, WALLS, JAMBS, ETC.), SHALL BE IN LINE WITH EACH OTHER.
7. CONTRACTOR SHALL MAINTAIN SITE IN A CLEAN AND ORDERLY CONDITION AT ALL TIMES.
8. CONTRACTOR SHALL PROTECT ALL SURFACES NOT INVOLVED IN THE WORK FROM ANY DAMAGE.
9. CONTRACTOR SHALL REPAIR ALL SURFACES DAMAGED DURING THE INSTALLATION OF ANY NEW BUILDING SYSTEM TO MATCH THE FINISH, APPEARANCE AND TEXTURE OF ADJACENT, EXISTING, UNDAIMAGED SURFACES.
10. ALL MATERIALS AND WORKMANSHIP SHALL BE GUARANTEED BY THE CONTRACTOR FOR ONE (1) YEAR FROM THE DAY OF SUBSTANTIAL COMPLETION.
11. CONTRACTOR SHALL PROVIDE ADEQUATE EROSION CONTROL DURING THE COURSE OF THE PROJECT.
12. ALL WOOD IN CONTACT W/ THE GROUND, BLASS ON GRADE, OR MASONRY TO BE PRESSURE TREATED.
13. ALL LUMBER TO BE DRIED TO 19% MOISTURE CONTENT. S4S, STAMPED PER GRADING.
14. DOORS & WINDOWS ARE CENTERED OR PLACED 4" FROM CORNER OF WALL U.N.O.
15. PARTITIONS ARE DIMENSIONED TO THE CENTERLINE. EXTERIOR WALLS ARE DIMENSIONED TO THE OUTSIDE FACE OF STUD.

RENOVATION TO

KAVANAUGH BLDG
HARRISONBURG, VIRGINIA

PROJECT NUMBER: 2017.0086

DATE: December 21, 2020

DRAWING INDEX

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KAVANAUGH BUILDING RENOVATIONS
HARRISONBURG, VIRGINIA

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CONTRACTOR:

KELCO BUILDERS

ARCHITECTURAL ABBREVIATIONS

@	At	CONT	Continuous	FLR	Floor	LVL	Laminated Veneer Lumber	PSI	Pound Per Square Inch	STRUCT	Structure
ABV	Above	CONTR	Contractor	FLUOR	Fluorescent	M.O.	Masonry Opening	PT	Pressure Treated	SUBFL	Subfloor
AC	Air Conditioning	CPT	Carpet	FOF	Face of Footing	MATL	Material	PTD	Painted	SURF	Surface
ACOUS	Acoustical	CORR	Corridor	FOM	Face of Masonry	MAX	Maximum	PVC	Polyvinyl Chloride	SUSP	Suspend
ACT/ACP	Acoustical Ceiling Tile/ Panels	CRS	Courses	FOS	Face of Structure(or Face of Stud, where applicable)	MDO	Medium Density Overlay	QT	Quarry Tile	SYM	Symbol
ADJ	Adjacent, Adjustable	CTR	Center	FP	Fireplace	MECH	Mechanical	QTY	Quantity		Tread(s)
AFF	Above Finish Floor	CTRD	Centered	FR	Fire Resistive	MEMB	Membrane	R	Riser(s);Radius	T&G	Tongue and Groove
A.I.A.	American Institute of Architects	CFCI	Contractor Furnished Contractor Installed	MFR	Manufacturer(s)	MIN	Minimum	RO	Rough Opening	TBS	To Be Specified
ALT	Alternate	DBL	Double	FT	Feet	MISC	Miscellaneous	R=	Radius	TEL	Telephone
ALUM	Aluminum	DEMO	Demolish, Demolition	FTG	Footing	MO	Masonry Opening	RAD	Radius	TEMP	Temperature
ANCH	Anchor	DET; DETL	Detail	FURN	Furniture	MTL	Metal	R.C.P.	Reflected Ceiling Plan	THK	Thick
ANOD	Anodized	DIA	Diameter	FURR	Furring	MTD	Mounted	RECPT	Receptacle	TLT	Toilet
A.P.A.	American Plywood Association	DN	Down	GA	Gauge	MTG	Mounting	REF	Refrigerator, Refer	TOF	Top of Footing
APPROX	Approximate	DS	Downspout	GAL	Gallon	MW	Microwave Oven	REFIN	Refinish	TOS	Top of Slab
ARCH	Architect (or Architectural)	DW	Dishwasher	GALV	Galvanized	N	North	REG	Register	TOST	Top of Structure
ASTM	American Society for Testing and Materials	DWG	Drawing	GB	Grab Bar	NEC	National Electric Code	REINF	Reinforcing	TOV	Top of Wall
AVG	Average	E	East	GC	General Contractor	NIC	Not in Contract	REPL	Replace(ment)	T.P.	Toilet Paper
A.W.I.	American Woodworking Institute	EA	Each	GFI	Ground Fault Interrupter	NO	Number	REQ;REQD	Required	TRTD	Treated
B.S.	Back Splash	EJ	Expansion Joint	GL	Glass	NOM	Nominal	RESIL	Resilient	TYP	Typical
BD	Board (or Bead, if applicable)	ELEC	Electric(al)	GWB	Gypsum Wall Board	#	Number	REV	Revision	UL:ULI	Underwriters Laboratories, Inc. Unless Noted Otherwise
BETW	Between	EL	Elevation	GYP	Gypsum	NTS	Not to Scale	RM	Room	UNO	
BLDG	Building	ELEV	Elevation	HB	Hose Bib	OFCL	Owner Furnished Contractor Installed	SAB	Sound Attenuation Blanket	UTIL	Utility
BLKG	Blocking	EMER	Emergency	HC	Hollow Core	OD	Outside Diameter	S	Shelf;Shelves	V	Volt
BOF	Base of Flooring	EQ	Equal	HCAP	Handicap	OC	On Center	SC	Solid Core	VB	Vapor Barrier
BOT	Bottom	EQUIP	Equipment	HD	Head	OFF	Office	SCHED	Schedule(d)	VCT	Vinyl Composition Tile
BRG	Bearing	ETR	Existing to Remain	HDW	Hardware	OHP	Outside Heat Pump	SCR	Screen	VIF	Verify in Field
BSMT	Basement	BWC	Electric Water Cooler	HDWD	Hardwood	OPG;OPNG	Opening	SDG	Siding	VT	Vinyl Tile
BYD	Beyond	EXIST	Existing	HORIZ	Horizontal	OPP	Opposite	SECT	Section	VWC	Vinyl Wall Covering
CEM	Cement	EXH	Exhaust	HT	Height	PART	Partition	SHT	Sheet	W	West
CJ	Control Joint	EXP	Expansion, Exposed	HVAC	Heating/Ventilation/Air- Conditioning	PGF	Powder Coat Finish	SHTG	Sheathing	WC	Water Closet
CLOS	Closet	EXT	Exterior	HW	Hot Water	PERIM	Perimeter	SIM	Similar	WD	Wood
CLG	Ceiling	FA	Fire Alarm	IN	Inch	PL	Plate	SMACNA	Sheet Metal & Air Conditioning Contractors National Association Specification	WDW	Window
CLOS	Closet	FD	Floor Drain	INCL	Include(d)	PLAM	Plastic Laminate	SPEC	Specification	WF	Wide Flange
CLR	Clear	FDTN	Foundation	INT	Interior	PLAS	Plaster	SQ	Square	WH	Water Heater
CMU	Concrete Masonry Unit	FEC	Fire Extinguisher Cabinet	JAN	Janitor	PLEX	Plexiglass	SS	Stainless Steel	WM	Western Wood Molding (designation)
CONC	Concrete	FF	Finish Floor	JT	Joint	PLMB	Plumbing	ST	Street	WP	Waterproofing
CONST	Construction	FGLAS	Fiberglass	KW	Kilowatt	PLYWD	Plywood	STD	Standard	W	Washer
		FIN	Finish	LAM	Laminate	PMVT	Pavement	SSM	Standing Seam Metal	W/	With
		FIX	Fixture	LAV	Lavatory	POLY	Polyethylene	STL	Steel	WT	Weight
		FLASHG	Flashing	LTG	Lighting	PR	Pair	STOR	Storage	WWF	Welded Wire Fabric
				LIN	Linoeum					YD	Yard

ARCHITECTURAL SYMBOLS

ROOM NAME
Room Number

Detail Number
DETAIL-SECTION

Detail Number
DETAIL-PLAN

Section Number
SECTION

Elevation Number
ELEVATION

Sheet Number
INT. ELEV. - PLAN

Window Symbol

Door Symbol

Partition Type

Bathroom Symbol

REVISION CLOUD & MARKER

KEYED NOTES

CENTERLINE

ALIGN - With Established Element

COLUMN LINE

ELEV. ABOVE FINISHED FLOOR - Plan

WOOD BLOCKING - Shim

WOOD BLOCKING - Continuous

WOOD - Finished

NEW WALL

EXISTING WALL TO BE REMOVED

EARTH

GRAVEL

CONCRETE

BRICK IN SECTION

BRICK IN ELEVATION

CONCRETE

MASONRY UNIT

GLASS

GWB (Large Scale)

MEDIUM DENSITY OVERLAY (MDO) BOARD/ ORIENTED STRAND BOARD (OSB)

PLYWOOD

LAY-IN CEILING TILE (Acoustical Panels)

INSULATION (Loose or Batt)

INSULATION (Rigid)

CARPET

CHANGE IN FLOOR LEVEL

PHOTO LOCATION

FLOOR MATERIAL

BASE MATERIAL

WALL MATERIAL

CEILING MATERIAL

PROJECT INFORMATION

GOVERNING CODE: VIRGINIA STATEWIDE BUILDING CODE, PART II, 2015
VIRGINIA EXISTING BUILDING CODE 2015, LEVEL 3, ADDITION & HISTORIC & ACCESSIBILITY - ANSI 117.1

USE GROUPS: EXISTING: R2 BASEMENT, R2, FIRST FLOOR & R2, FLOORS 2-3
PROPOSED: R2 BASEMENT; M & R2, FIRST FLOOR & R2, FLOORS 2-3

CONSTRUCTION TYPE: 3B UNPROTECTED

HEIGHT: EXISTING BLDG - 3 STORIES & BASEMENT, 46'-4"
PROPOSED 3 STORIES & BASEMENT, 46'-4"
ALLOWABLE PER TABLE 504.3 - 75'-0" FOR FULLY SPRINKLER BUILDING

AREA: EXISTING BLDG - 3 STORIES & BASEMENT @ 4,850 SF = 19,400 SF
PROPOSED - 3 STORIES & BASEMENT @ 4,850 = 19,400 SF
ALLOWABLE AREA: 37,500 SF BASED ON M 48,000 SF BASED ON R2

OCCUPANCY: BASEMENT: 22 BASED ON 1/200 SF IN 4 APTS. & 1/300 SF STORAGE
FIRST FLOOR - 19 BASED ON 1/200 SF IN 5 APTS & 16 BASED ON 60 SF MERCANTILE
FLOORS 2-3: 19 BASED ON 1/200 SF IN 16 APTS
ORIGINAL BUILDING HAD 22 UNITS. PROPOSED LAYOUT HAS 25 UNITS.

FIRE SUPPRESSION: EXISTING BLDG - FULLY SPRINKLERED
ADDITION - FULLY SPRINKLERED NFPA 13

FIRE DETECTION: & ALARM

ALARMS & SMOKE DETECTION

NUMBER OF EXITS: ALL OTHER FLOORS 2 PROVIDED; NEW FIRE ESCAPE FOR FLOORS 1-3

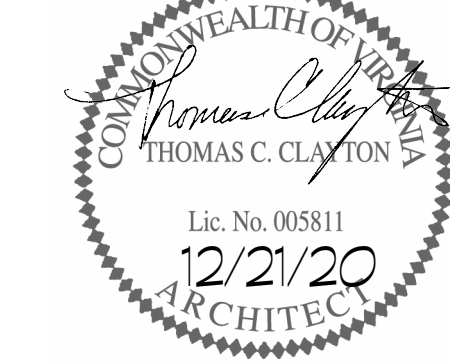
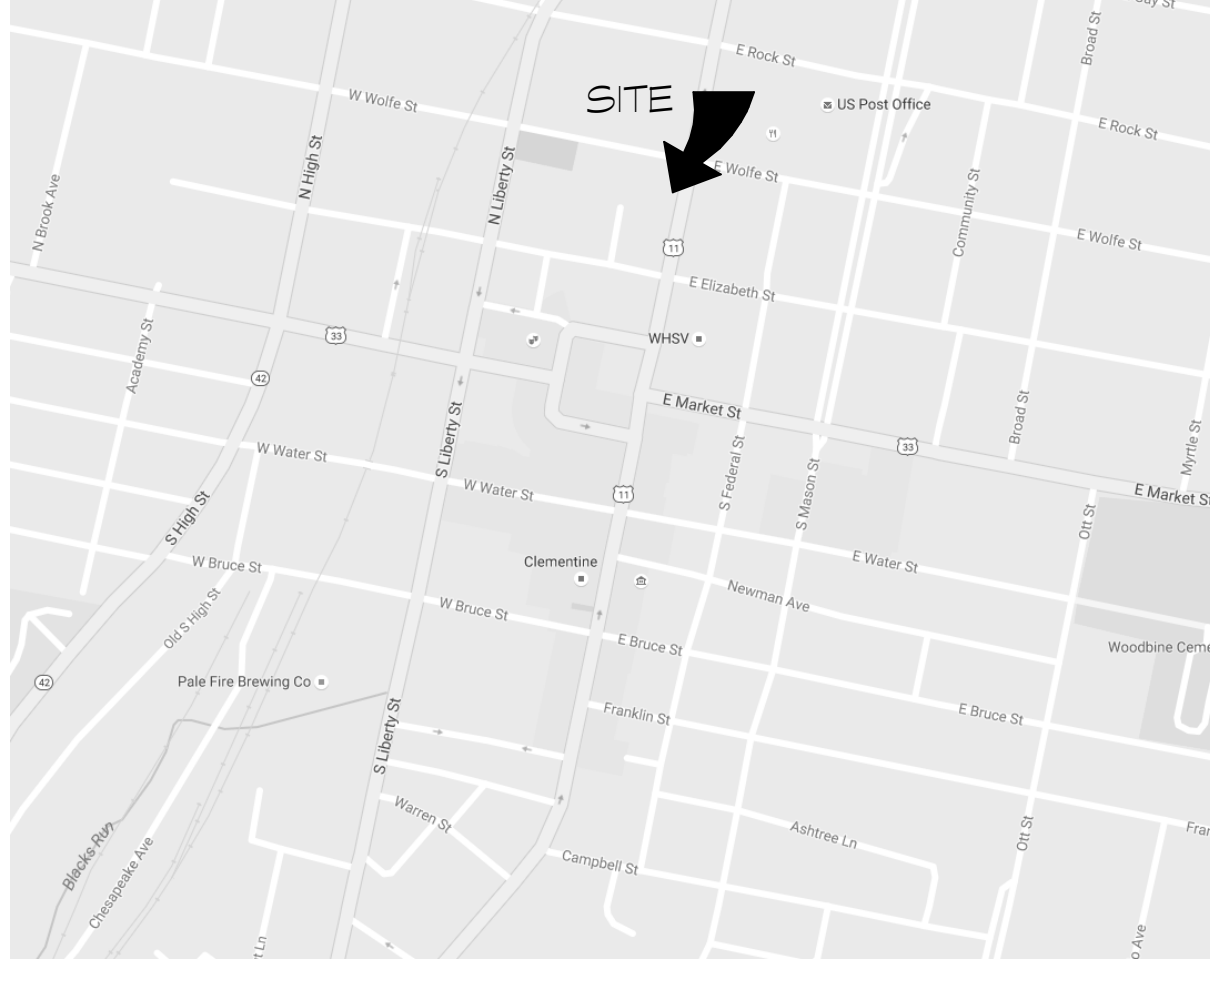
DEAD ENDS: MAXIMUM DEAD PERMITTED IN A SPRINKLERED BLDG - 50' - 36'-7" ON FLOORS 1-3

REFER TO FS 11 FOR ADDITIONAL CODE ANALYSIS

VICINITY PLAN



LOCATION PLAN



DRAWING SET:

BID SET


DRAWING TITLE:

TITLE SHEET

TS.1

These plans have been approved by VDHR and NPS regarding historic tax credits and any changes made without prior review and approval by the architect and VDHR/NPS could endanger the owner's use of the credits.



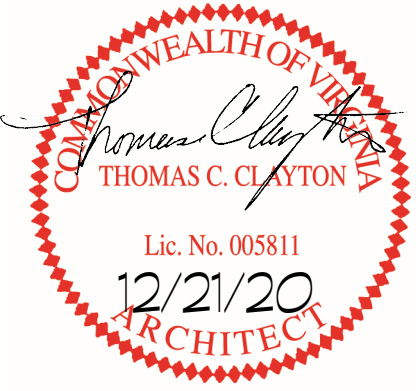


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KAVANAUGH BUILDING RENOVATIONS

HARRISONBURG, VIRGINIA

DATE	REVISION
3/26/2021	COL SIZES
3/26/21	REISSUED



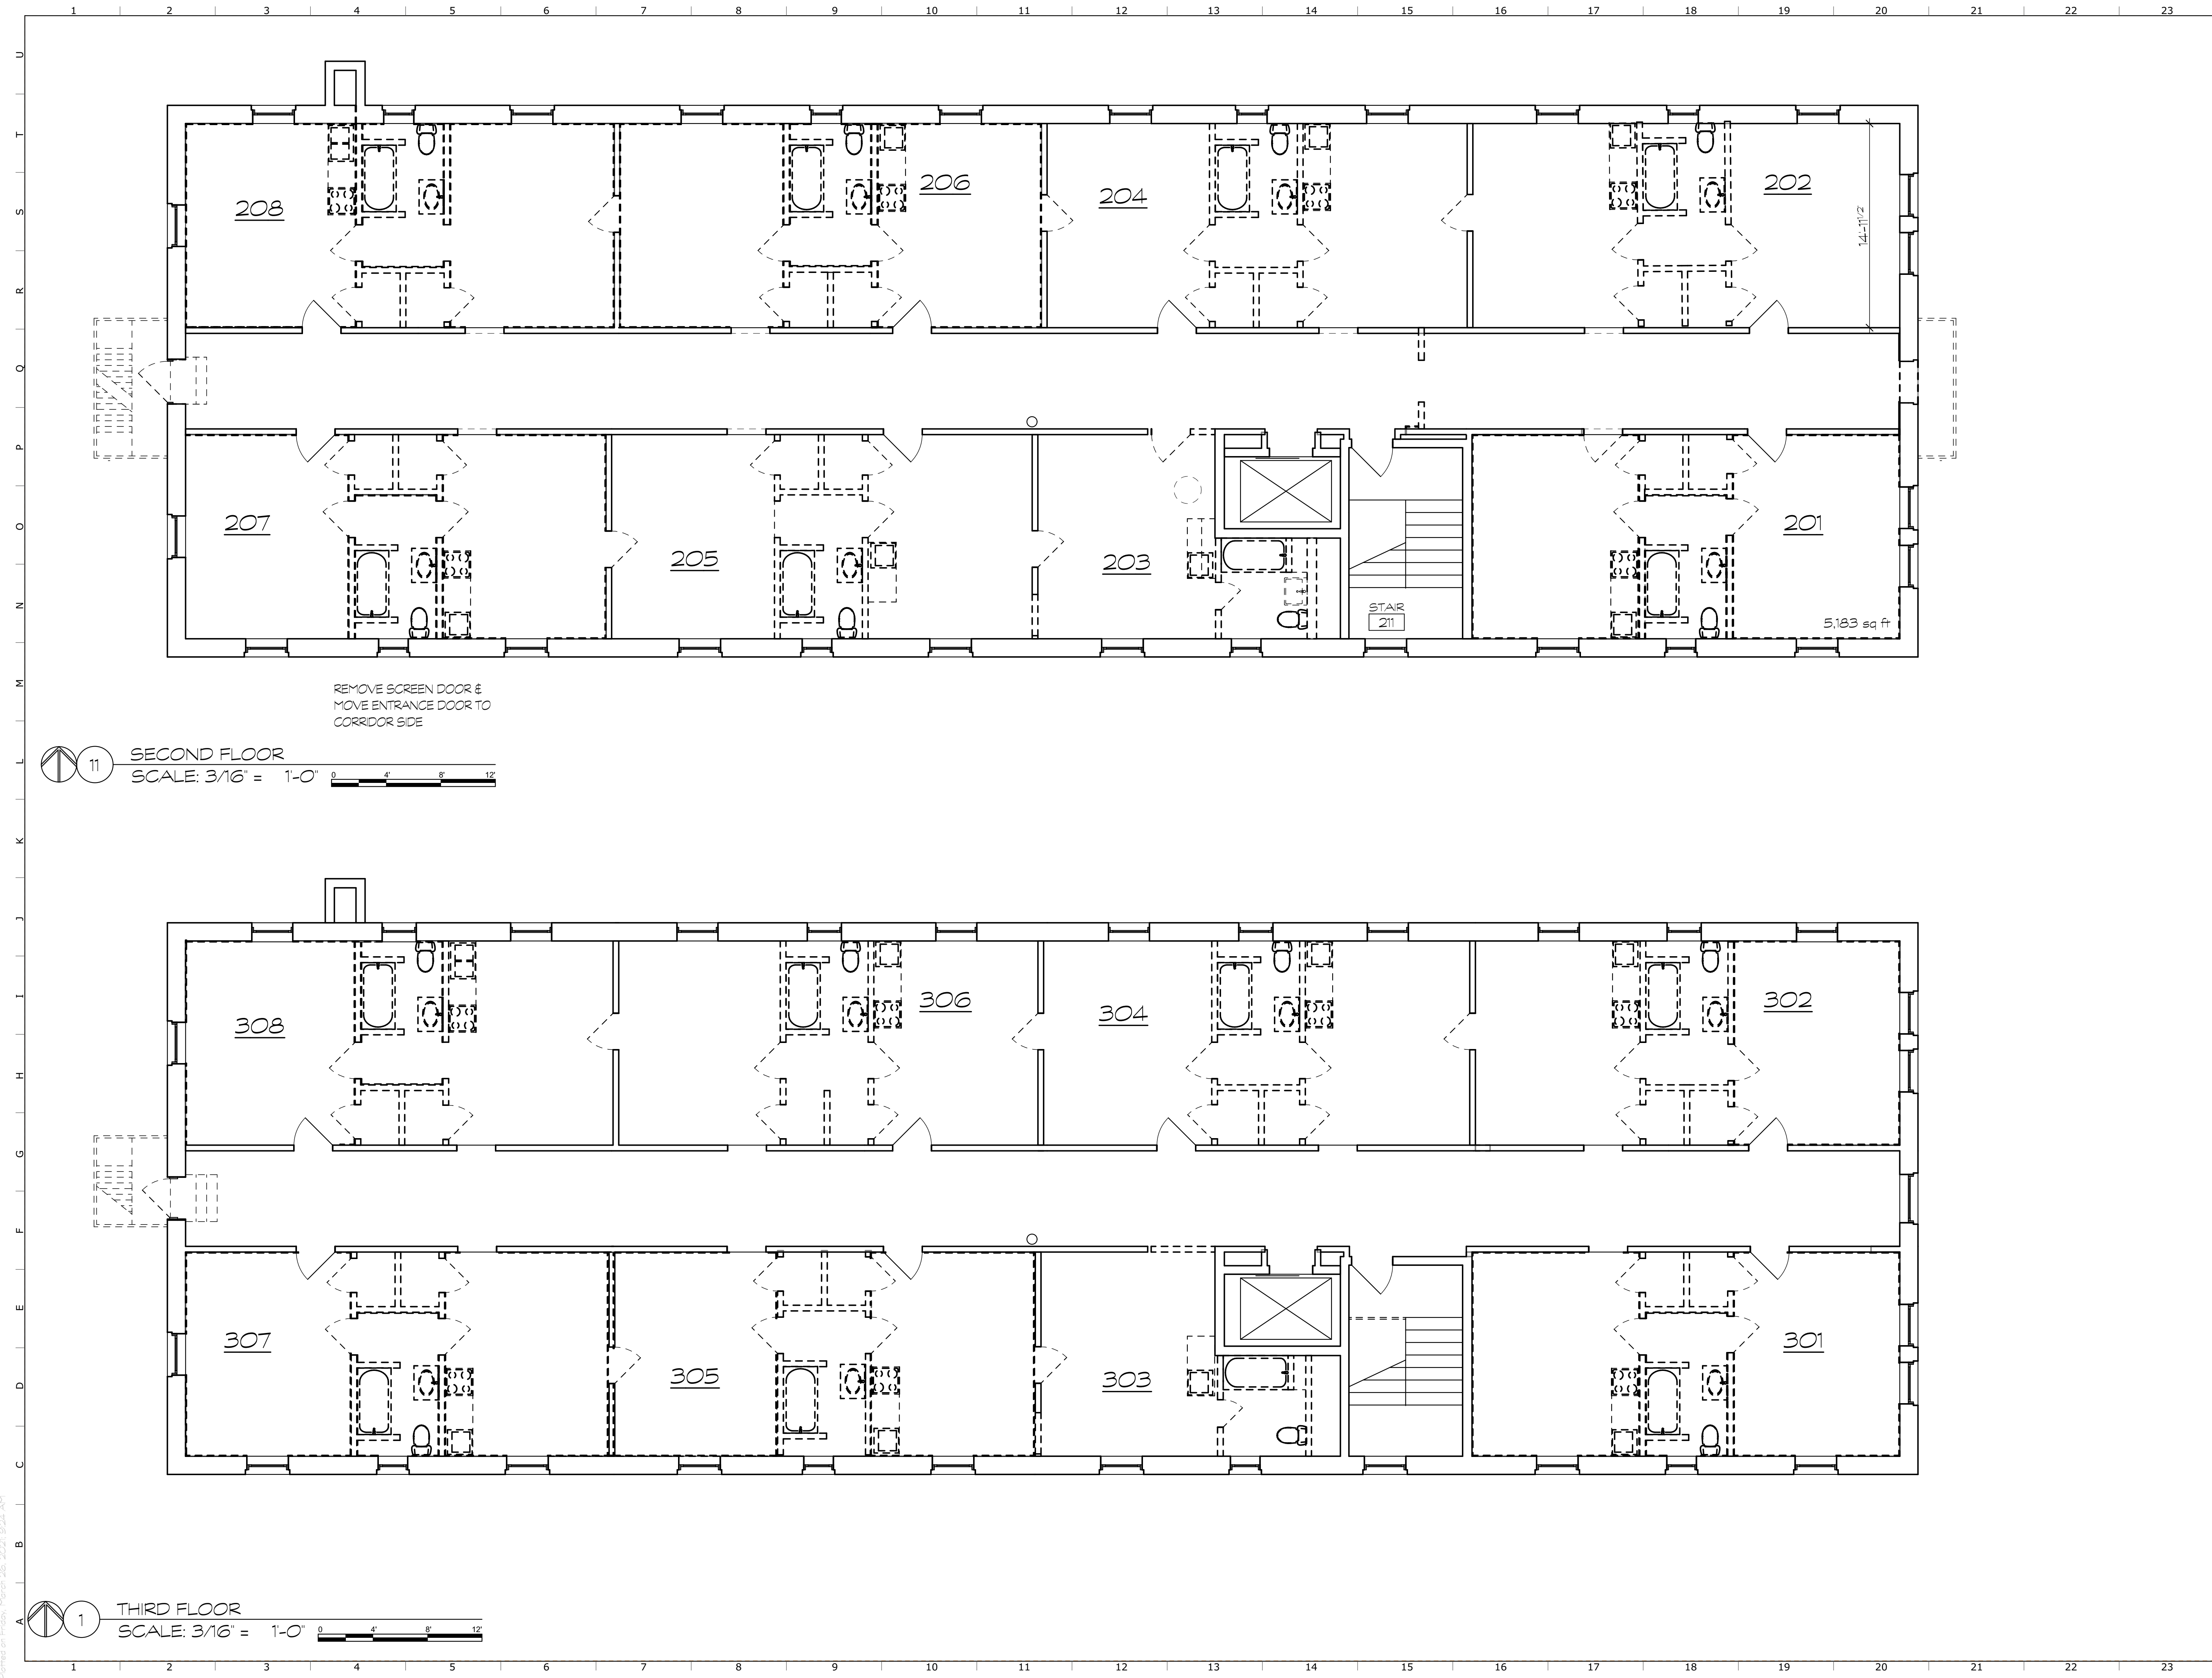
THOMAS C. CLAYTON
Lic. No. 005811
12/21/20
ARCHITECT

PROJECT NUMBER:	SCALE:
2017.0086	AS NOTED
PROJECT MANAGER:	CHECKED BY:
DRAWN BY:	DATE:
	12/21/2020

DRAWING TITLE:
DEMO PLAN - BASEMENT & FIRST FLOOR PLANS

AD.1

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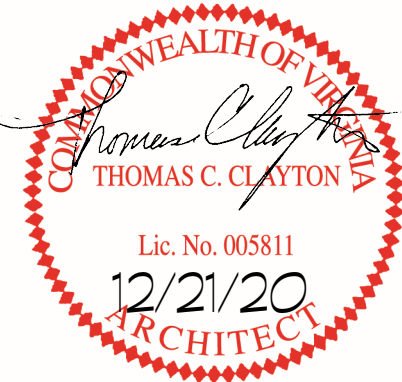
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KAVANAUGH BUILDING RENOVATIONS

HARRISONBURG, VIRGINIA

DATE	REVISION
3/9/21	REISSUED
3/26/21	REISSUED

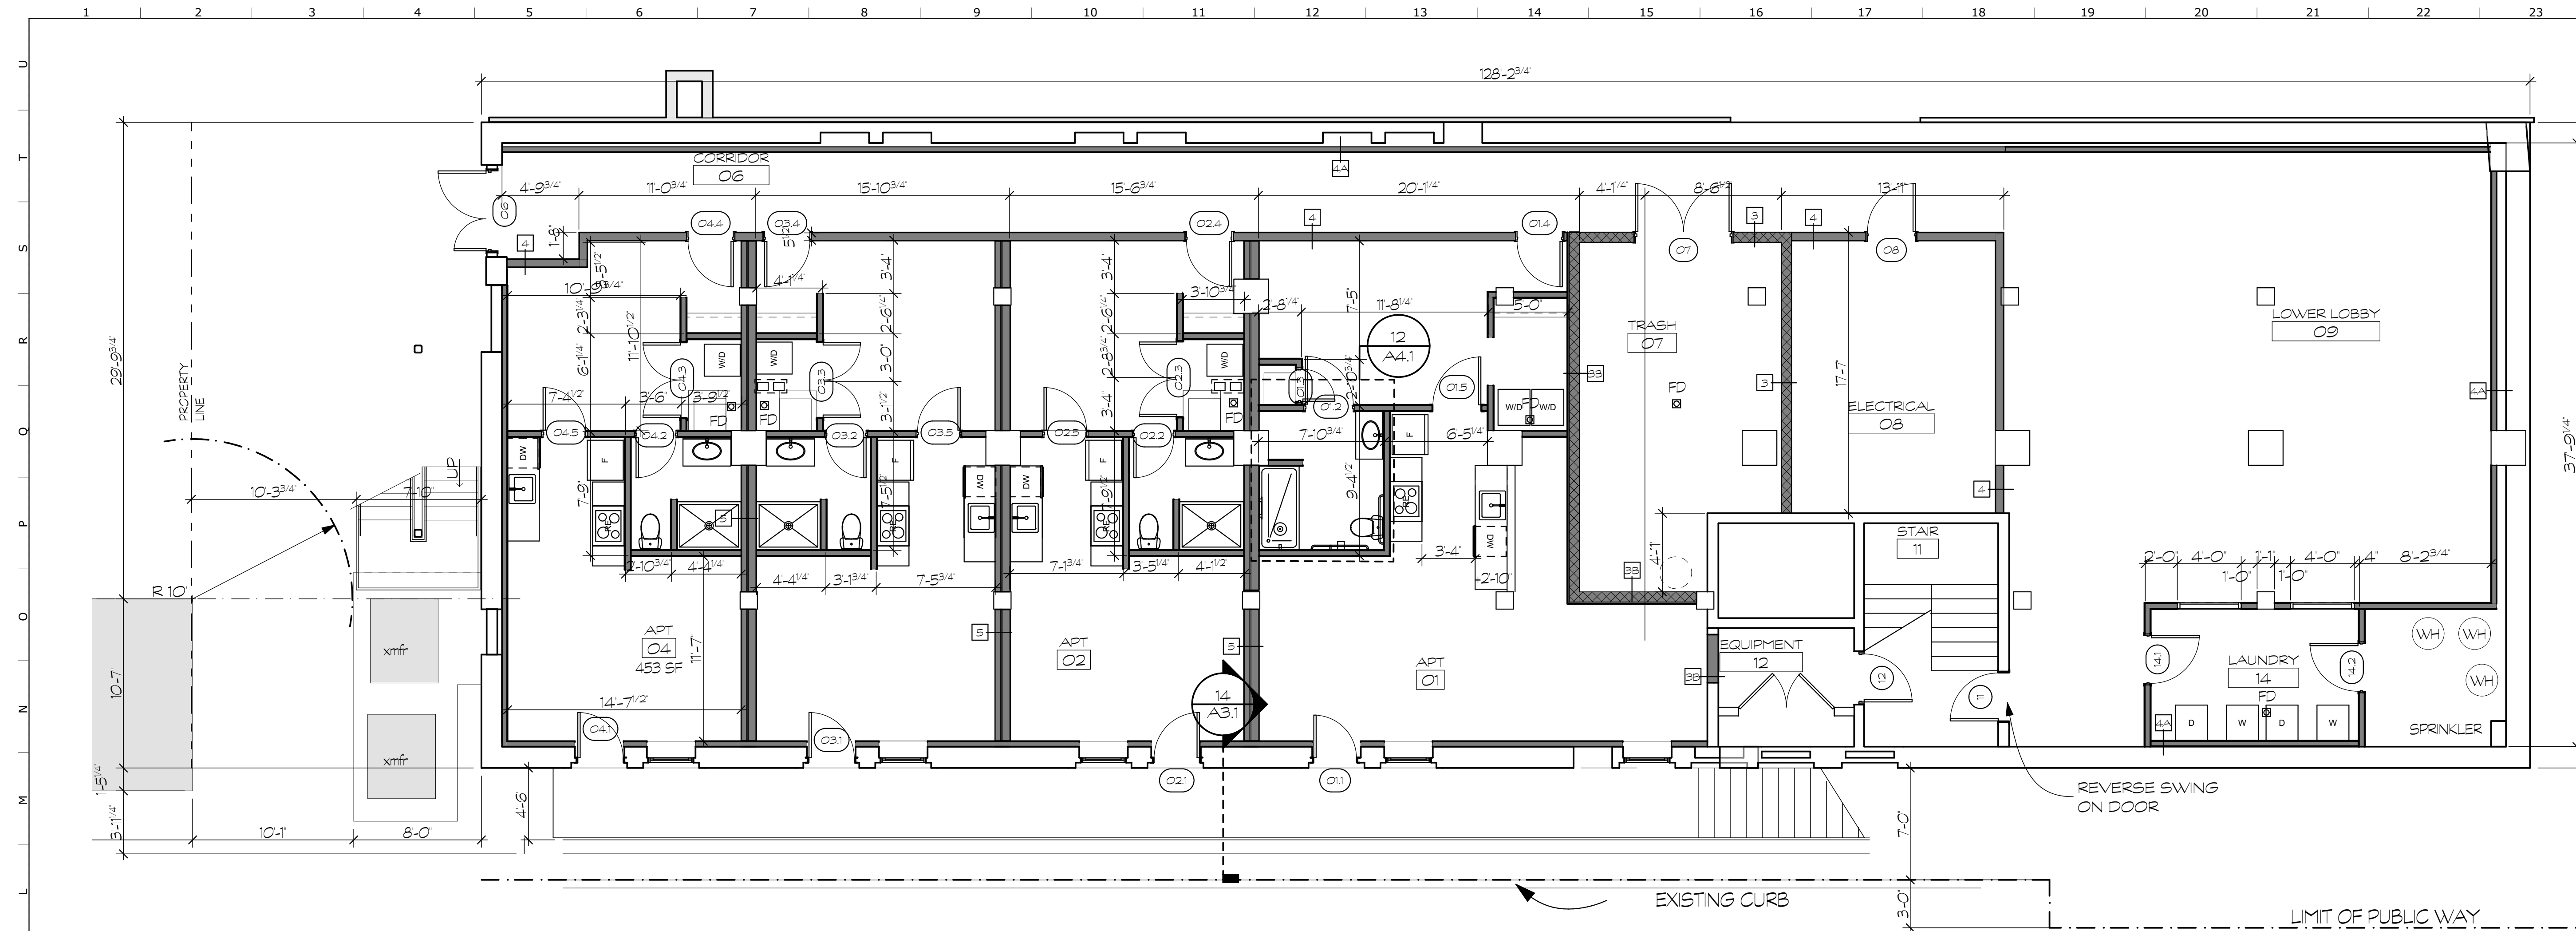


PROJECT NUMBER: 2017.0086	SCALE: AS NOTED
PROJECT MANAGER:	CHECKED BY:
DRAWN BY:	DATE: 12/21/2020

DRAWING TITLE:
DEMO PLAN - SECOND & THIRD FLOORS

AD.2

These plans have been approved by VDHR and NPS regarding historic tax credits and any changes made without prior review and approval by the architect and VDHR/NPS could endanger the owner's use of the credits.

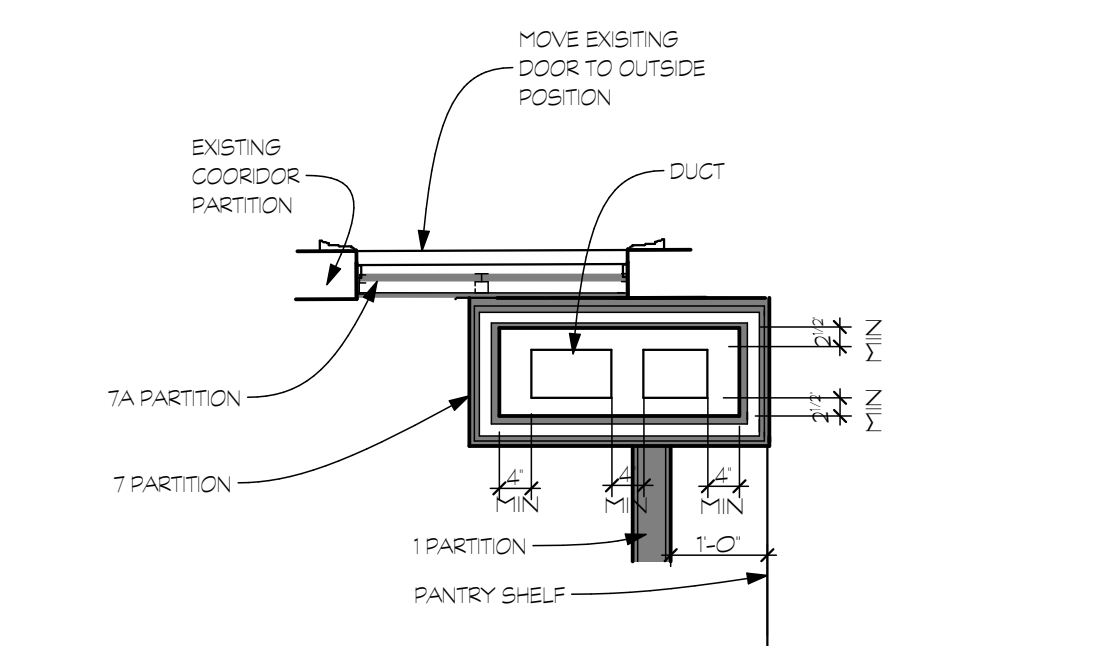


11 PROPOSED GROUND
SCALE: 3/16" = 1'-0"

1		1	TYPICAL PARTITION, U.N.O. 5/8" GWB EA SIDE OF 2X4 STUD
		1A	1 HOUR PARTITION WITH TYPE X GWB; UL DES # U305
		1B	30 MIN PARTITION WITH TYPE X GWB; UL DES # U407
		1C	1 HOUR PARTITION WITH TYPE X GWB; UL DES # U305, 2X6 STUDS & 5" S&B
2		2	APT. SEPARATION
		2A	2 1/2" CH STUD & 2" S&B
3		3	2-HOUR RATED UL DES # U906
		3A	1-HOUR RATED UL DES # U906 W/ 7/8" FURRG & 5/8" GWB
		3B	2-HOUR RATED UL DES # U906 W/ 7/8" FURRG & 5/8" GWB
		3C	30 MIN RATED UL DES # U906 W/ 7/8" FURRG & 5/8" GWB
4		4	AS SHOWN
		4A	2X4 STUD & GWB ONE SIDE

1 PARTITION TYPES
SCALE: 3/4" = 1'-0"

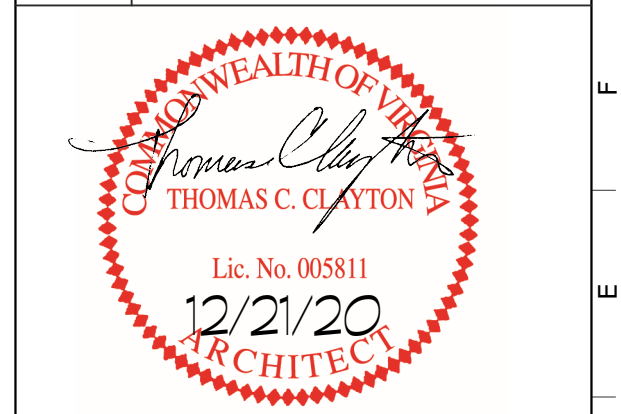
5		5	NOT USED
6		6	2 HOUR PARTITION WITH TYPE X GWB; UL DES # U308
7		7	2-HOUR RATED @ SHAFTWALL, UL DES # U415
		7A	1-HOUR RATED @ SHAFTWALL, UL DES # U415, 1 LAYER 5/8" GWB



5 CHASE DETAIL
SCALE: 1/2" = 1'-0"

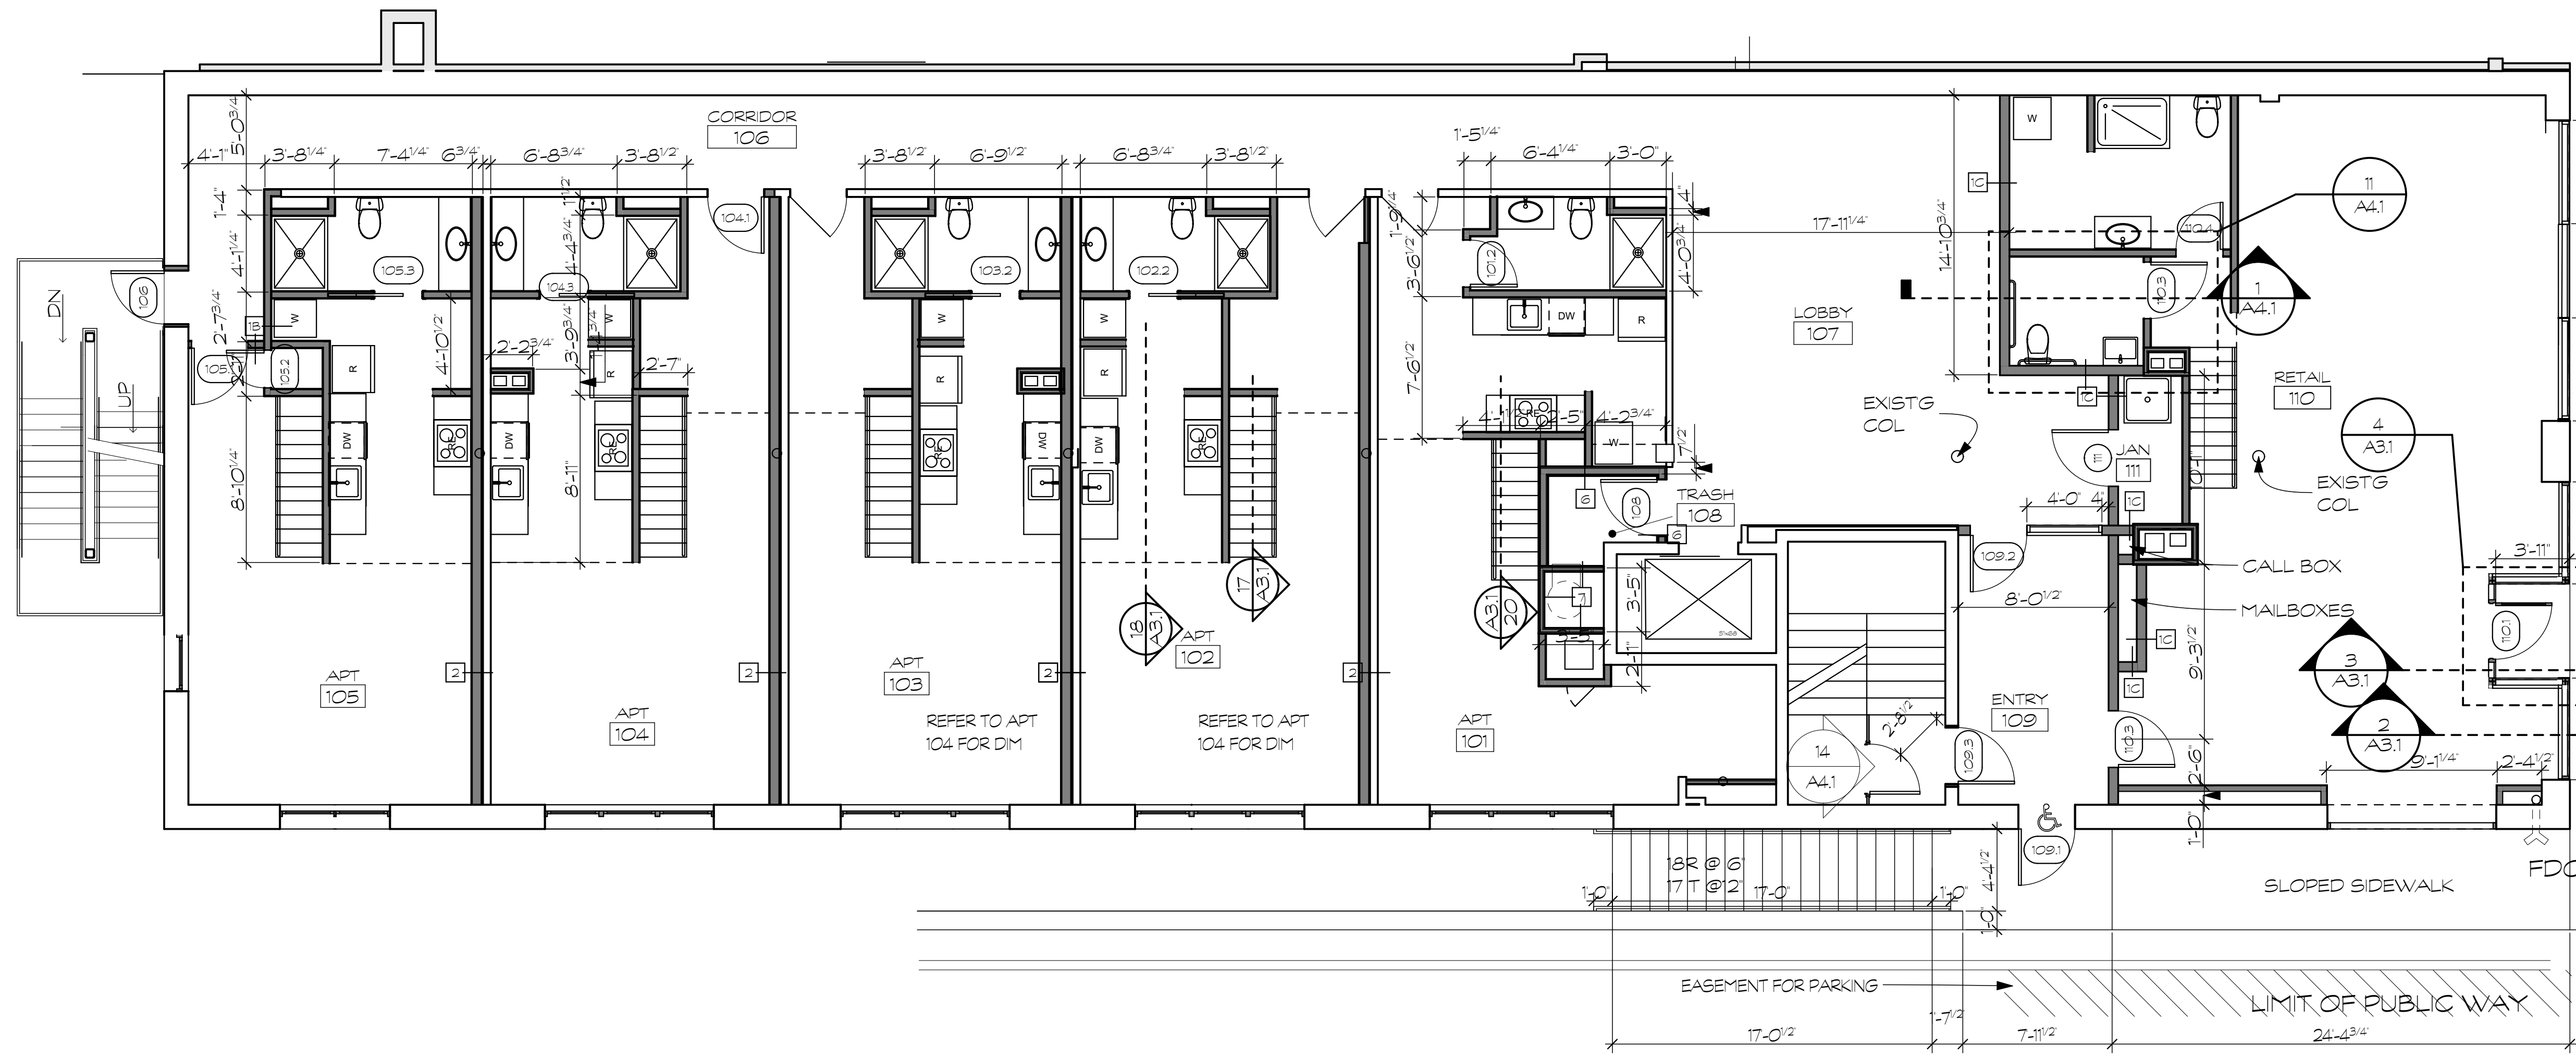
KAVANAUGH BUILDING RENOVATIONS
HARRISONBURG, VIRGINIA

DATE	REVISION
2/3/2021	COL SIZES, LAUNDRY RM
3/26/21	REISSUED

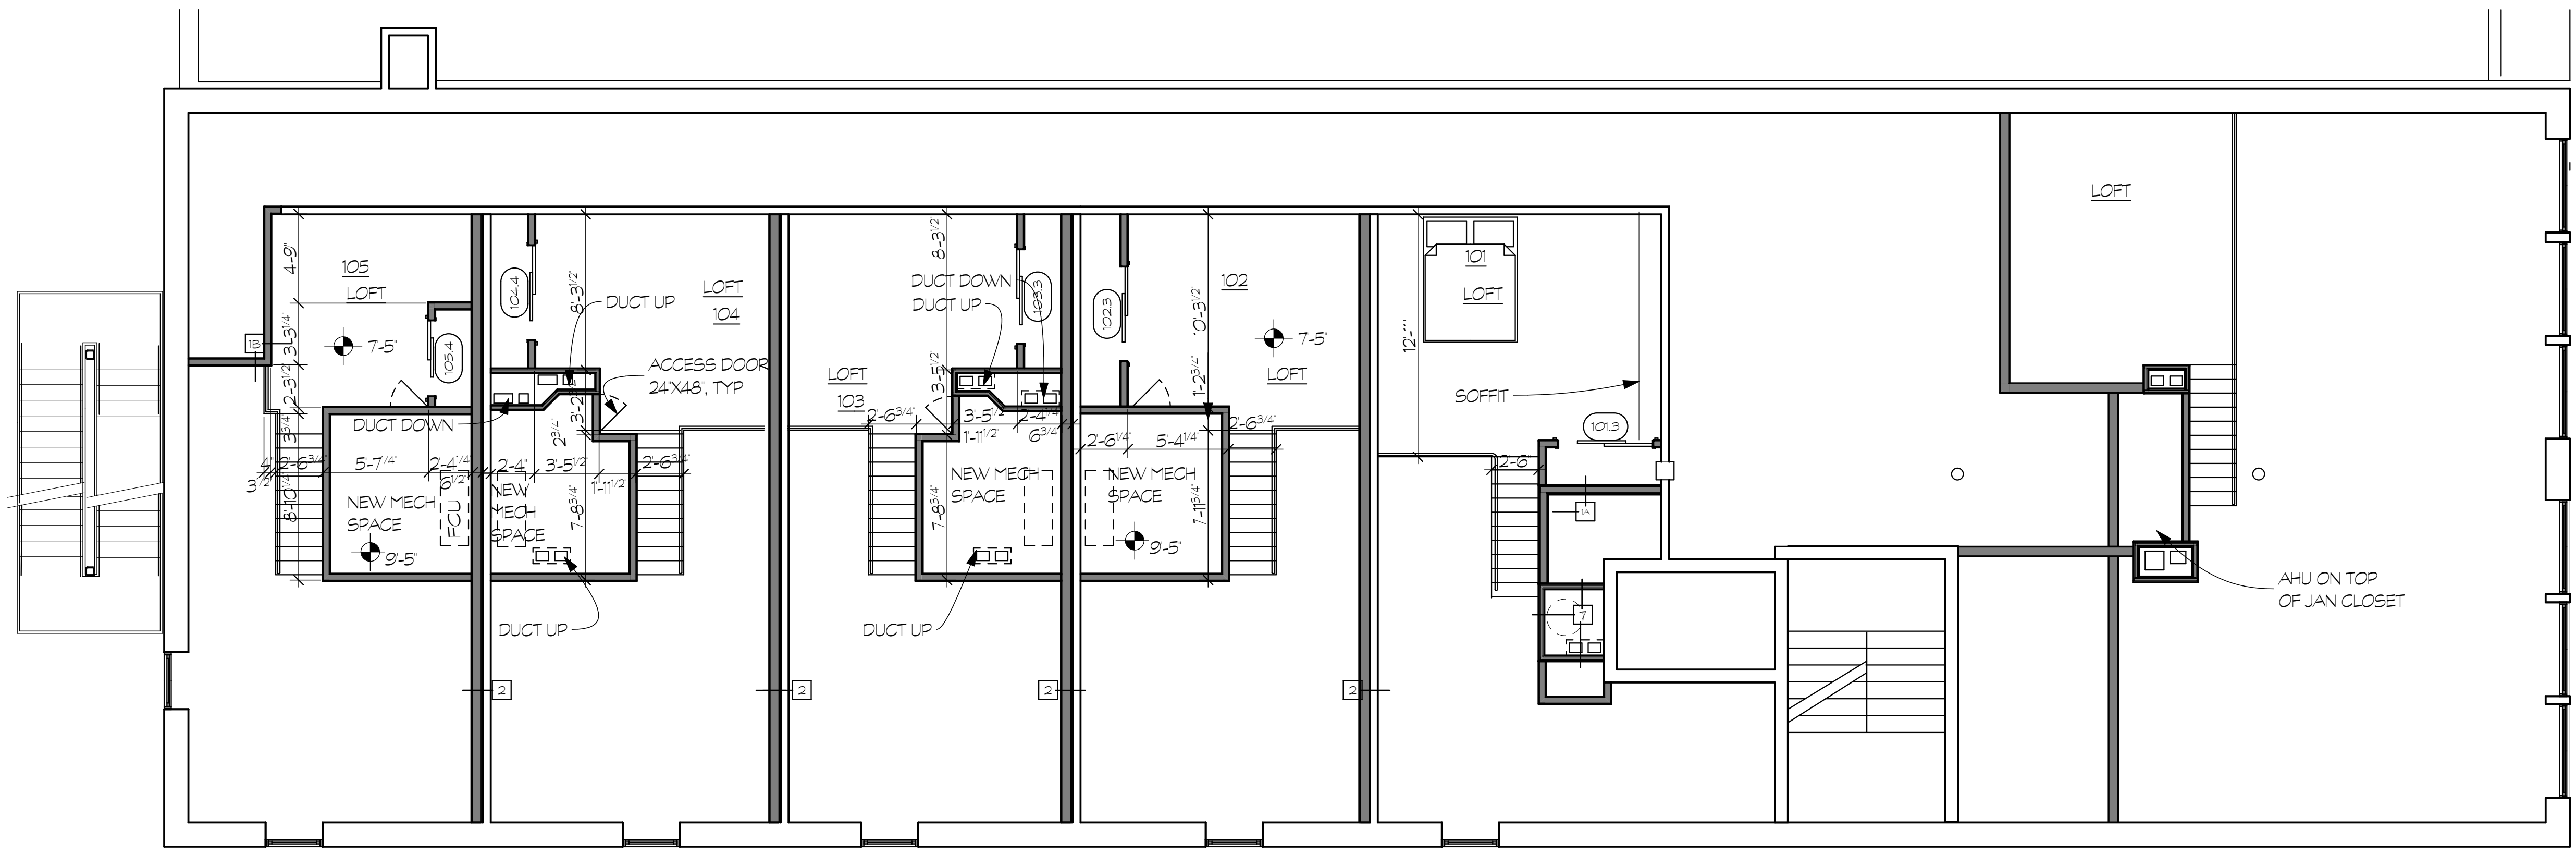


PROJECT NUMBER: 2017.0086	SCALE: AS NOTED
PROJECT MANAGER:	CHECKED BY:
DRAWN BY:	DATE: 12/21/2020
DRAWING TITLE: GROUND FLOOR PLAN	

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11 PROPOSED FIRST FLOOR
SCALE: 3/16" = 1'-0" 0 4 8 12



1 PROPOSED MEZZANINE
SCALE: 3/16" = 1'-0" 0 4 8 12

ENTIRE FLOOR TO HAVE GWS CEILINGS

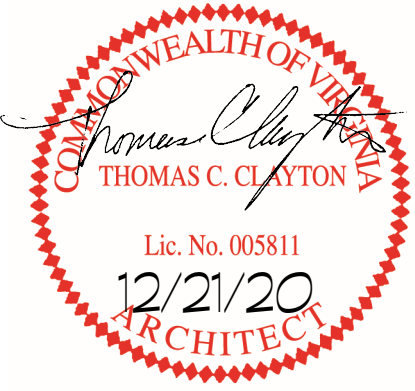


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HARRISONBURG, VIRGINIA

DATE	REVISION
2/3/21	APT 101
3/26/21	REISSUED



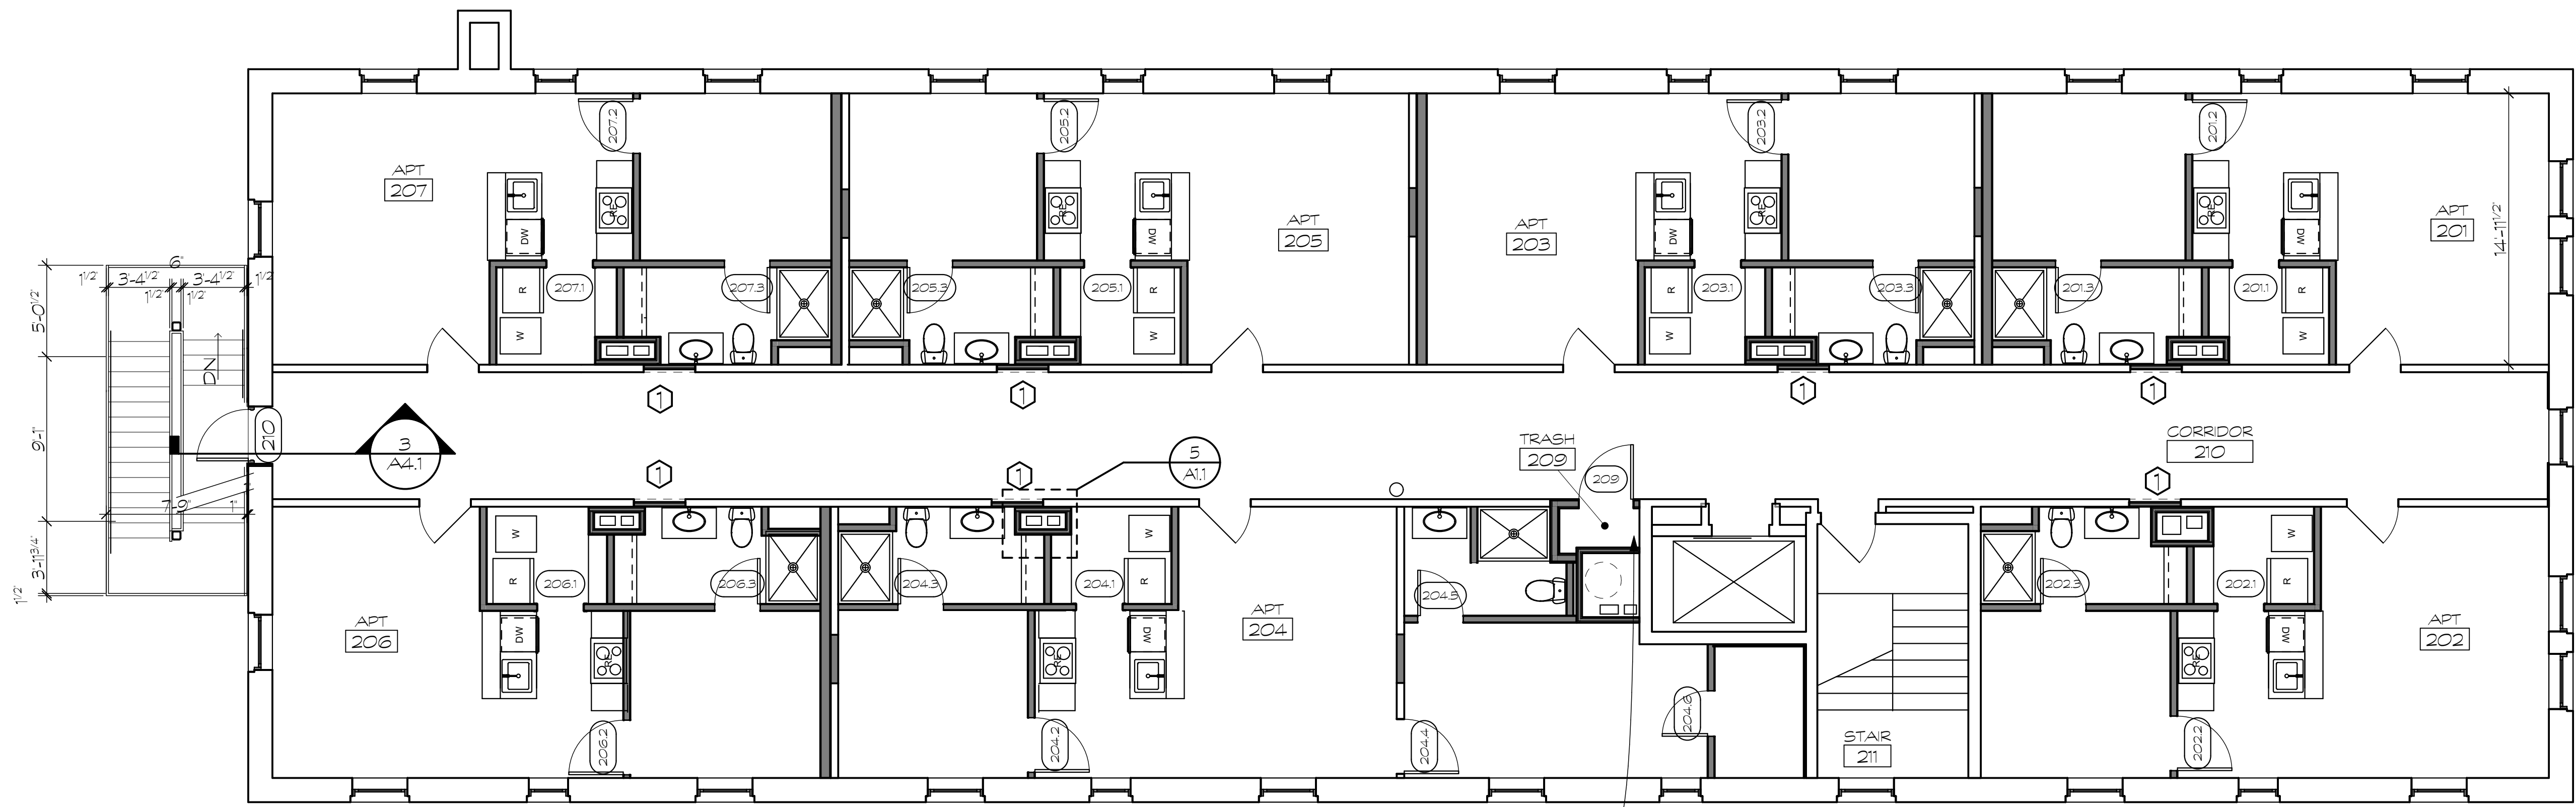
PROJECT NUMBER:	SCALE:
2017.0086	AS NOTED
PROJECT MANAGER:	CHECKED BY:
DRAWN BY:	DATE:
	12/21/2020

DRAWING TITLE:
FIRST & MEZZANINE FLOOR PLANS

A1.2

These plans have been approved by VDHR and NPS regarding historic tax credits and any changes made without prior review and approval by the architect and VDHR/NPS could endanger the owner's use of the credits.

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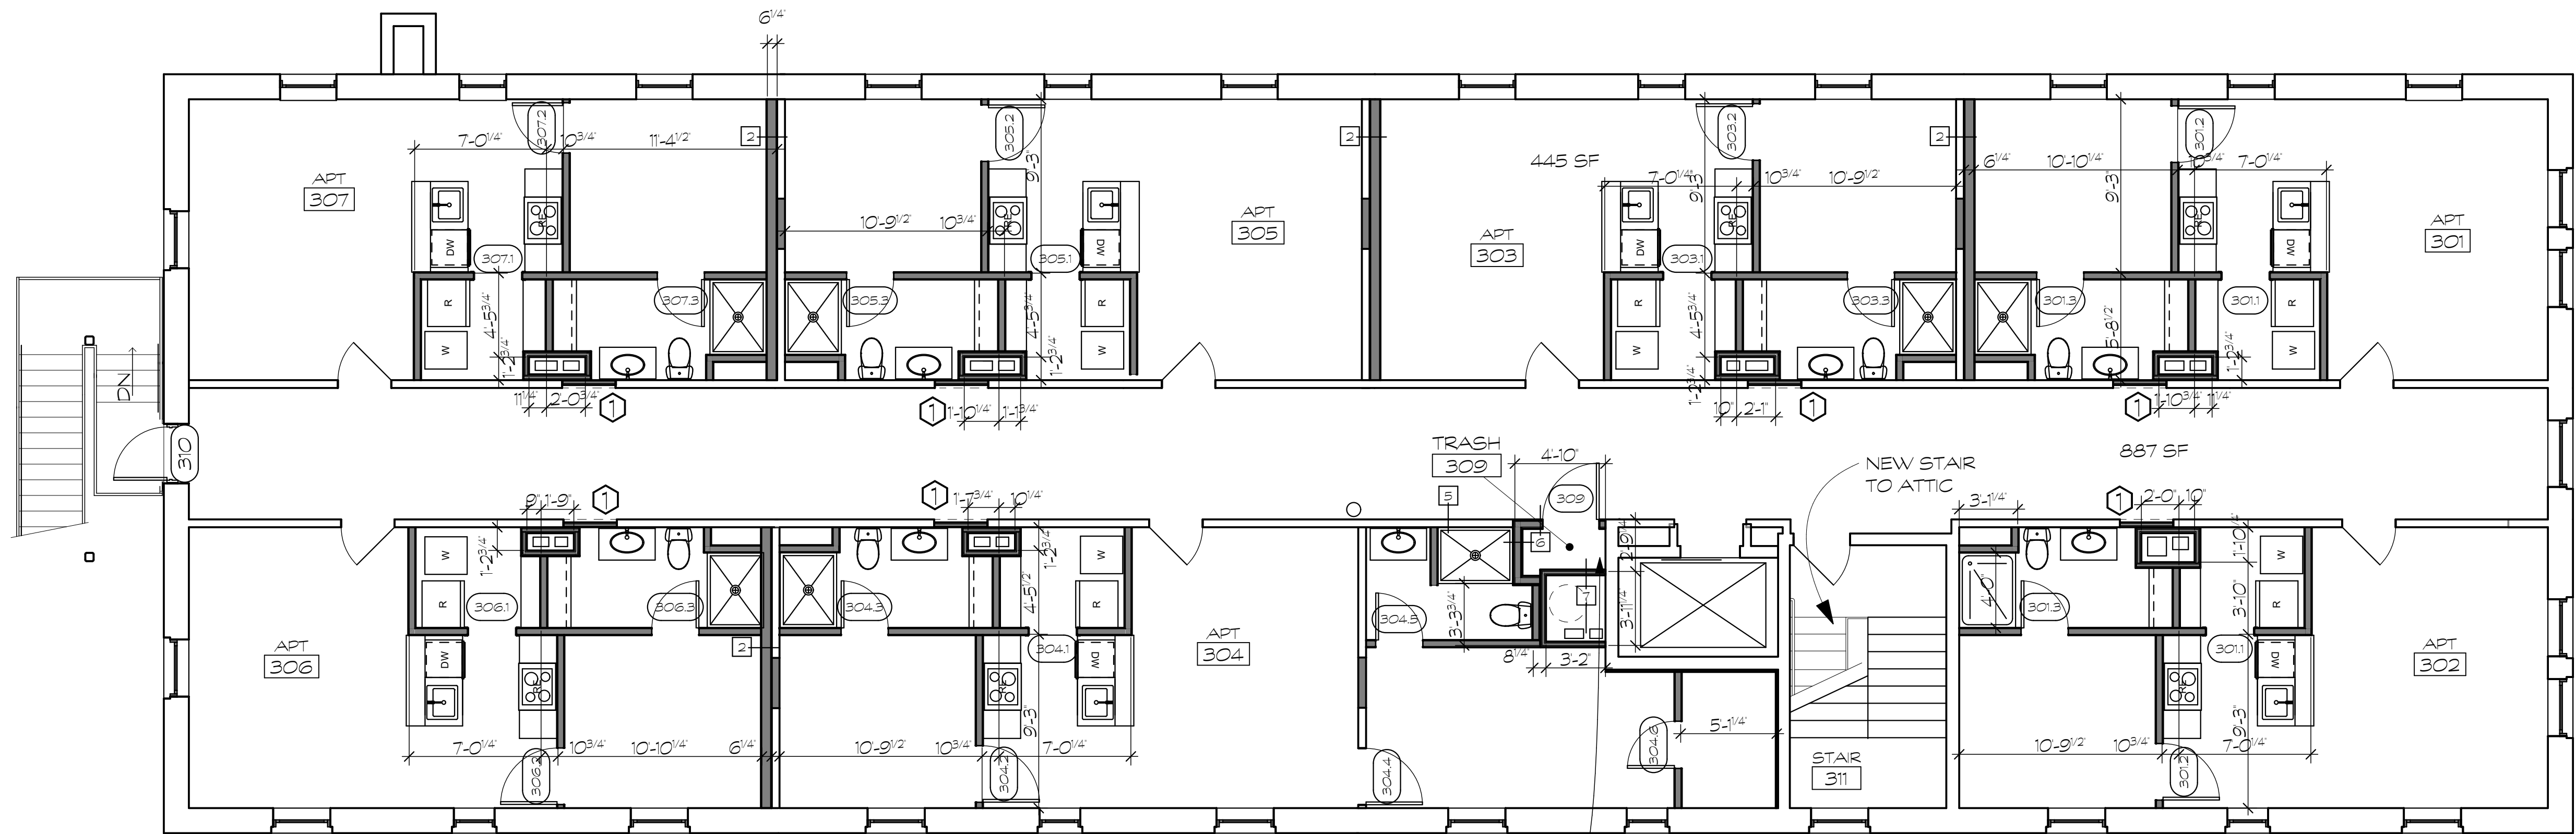


11 SECOND FLOOR PROPOSED
SCALE: 3/16" = 1'-0" 0 4' 8' 12'

REFER TO THIRD FLOOR PLAN FOR ADDITIONAL NOTES & DIMENSIONS

1 REMOVE SCREEN DOOR &
MOVE ENTRANCE DOOR TO
CORRIDOR SIDE

MOUNT RES MTL FURRING TO
UNDERSIDE OF EXISTING CLG
& INSTALL 5/8" TYPE C GWB
TO CHANNELS UL#511



1 PROPOSED THIRD FLOOR
SCALE: 3/16" = 1'-0" 0 4' 8' 12'

MOUNT RES MTL FURRING TO
UNDERSIDE OF EXISTING CLG
& INSTALL 5/8" TYPE C GWB
TO CHANNELS UL#511

BOTH FLOORS TO
HAVE GWB CEILINGS



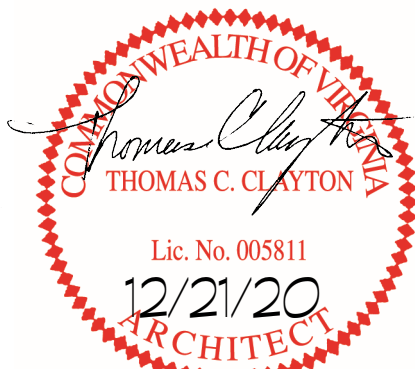
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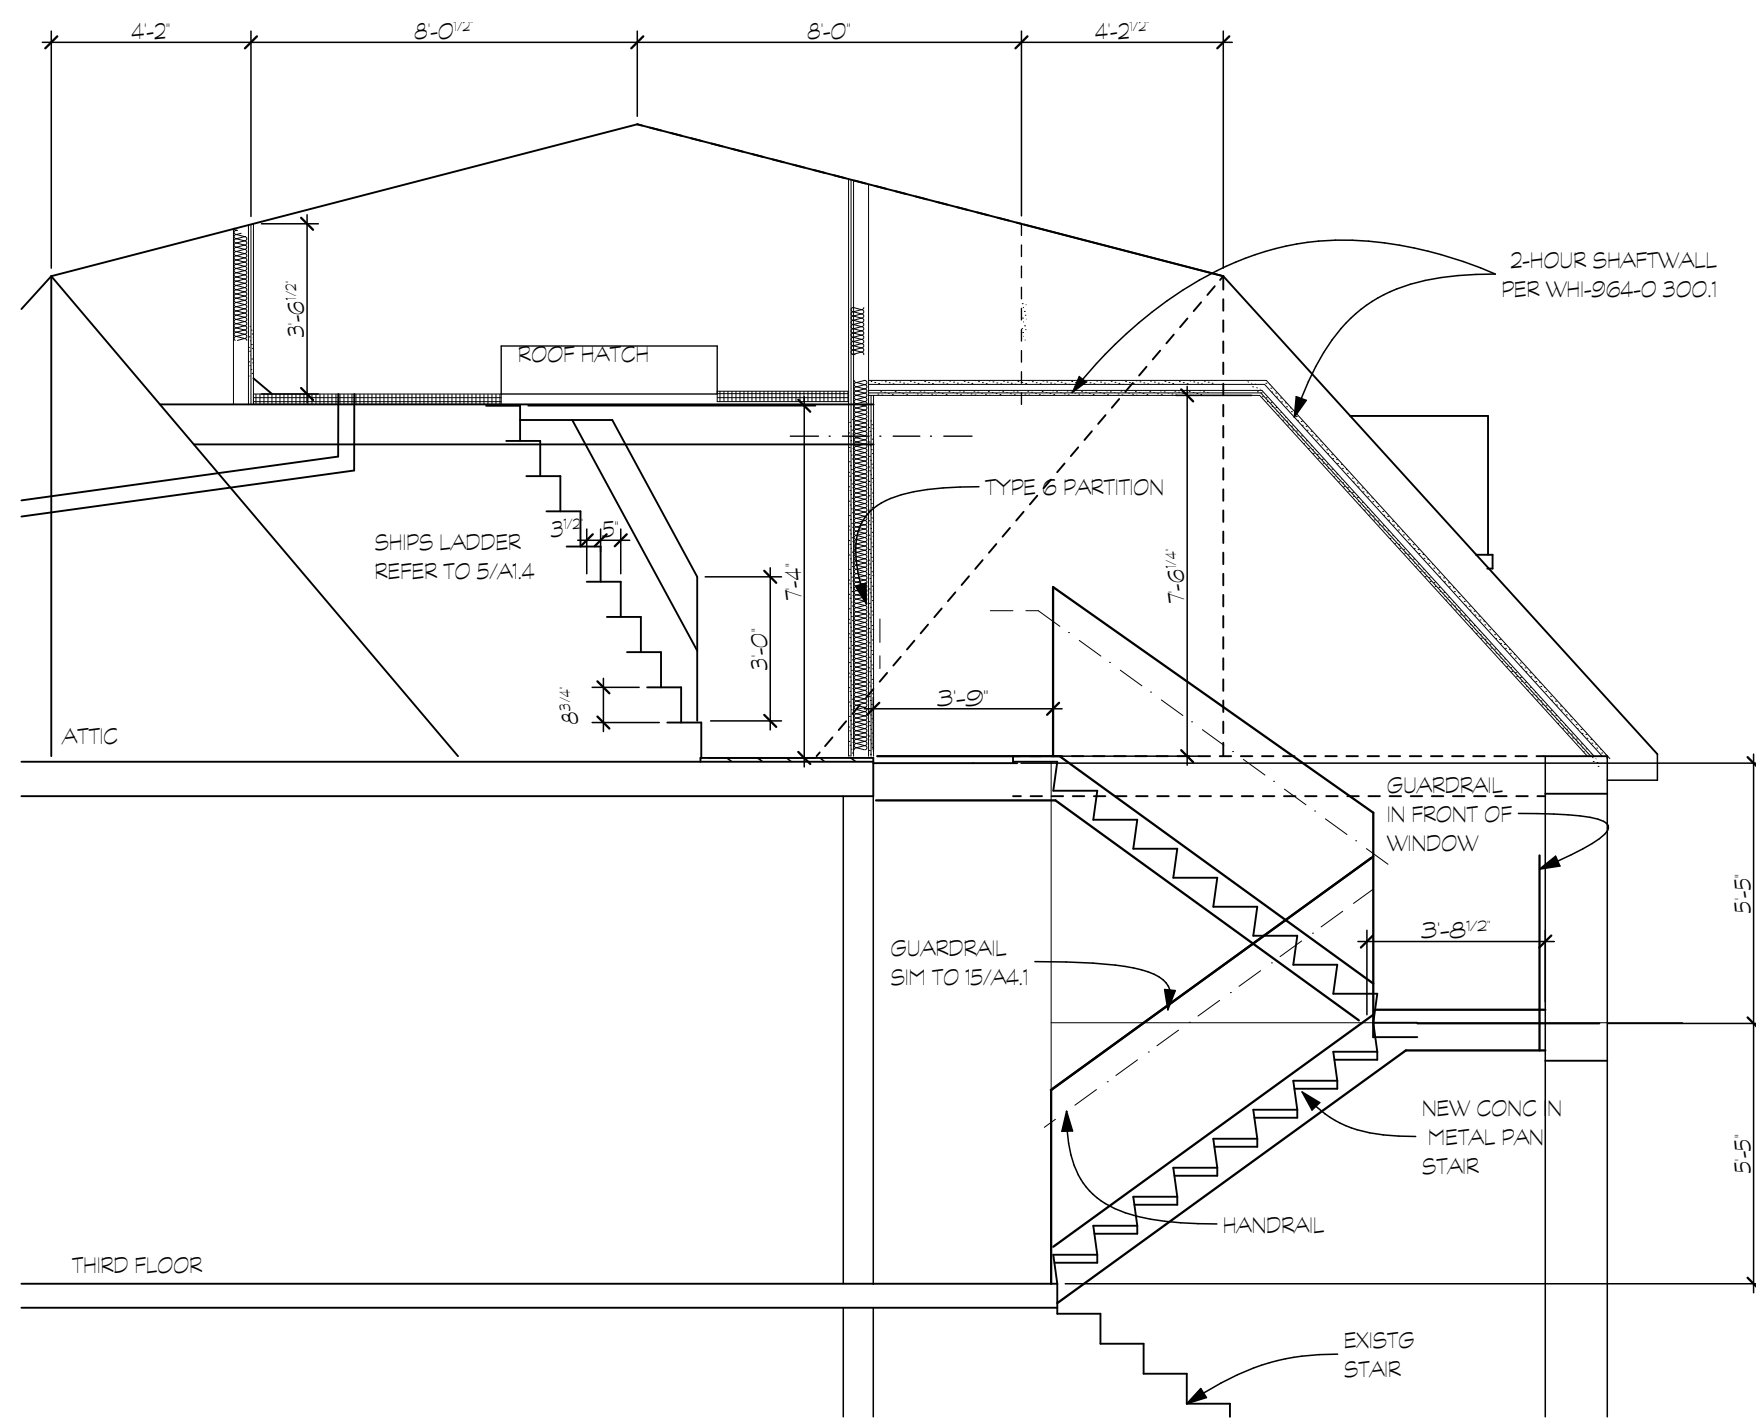
DATE	REVISION
2/24/2021	SHOWER SIZE
3/26/21	REISSUED



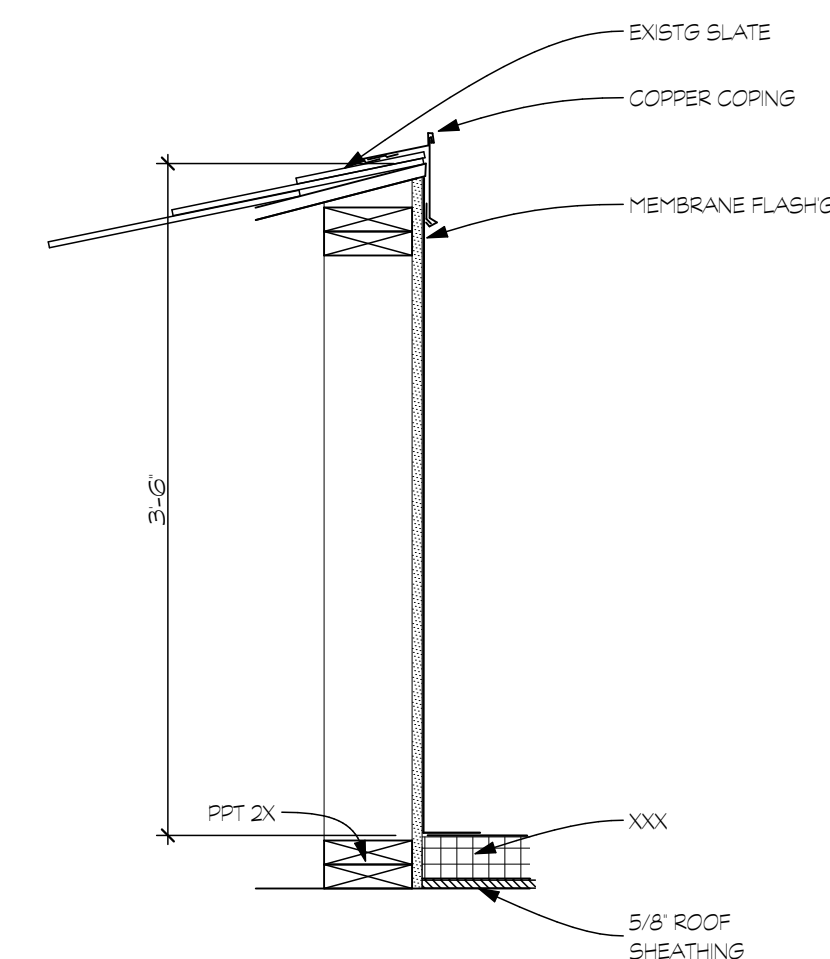
PROJECT NUMBER: 2017.0086	SCALE: AS NOTED
PROJECT MANAGER:	CHECKED BY:
DRAWN BY:	DATE: 12/21/2020
DRAWING TITLE: SECOND & THIRD FLOOR PLANS	


A1.3

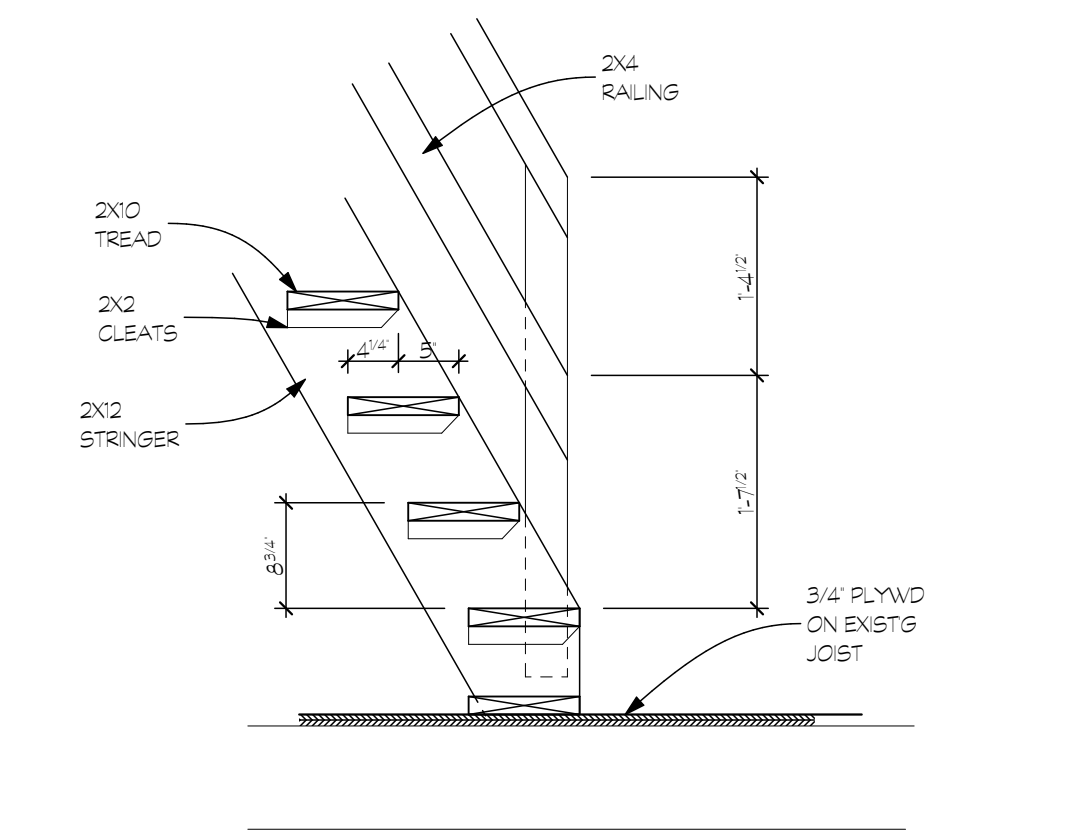
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
14 ATTIC/ROOF ACCESS
SCALE: 1/4" = 1'-0"



9 ROOF DETAIL
SCALE: 1" = 1'-0" 



5 SHIPS LADDER DETAIL
SCALE: $\frac{3}{4}" = 1'-0"$



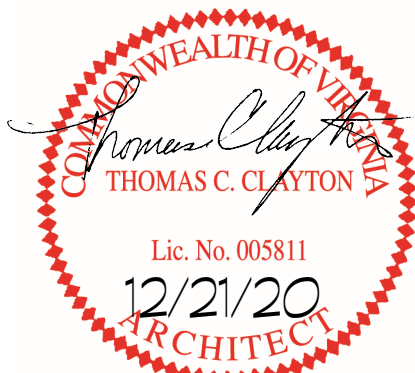
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3/9/21	REISSUED
3/26/21	REISSUED



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DRAWN BY:	DATE: 12/21/2020

DRAWING TITLE:
ATTIC & ROOF PLANS

A1.4

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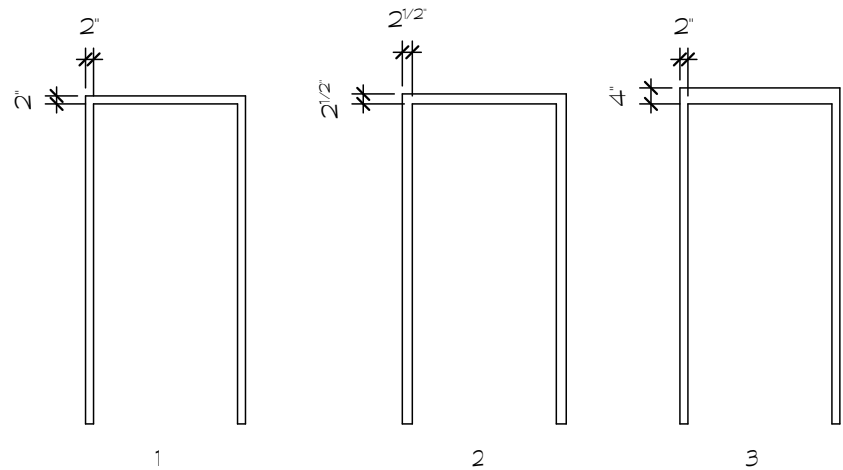
Printed on Friday, 12/26/2020 9:24 AM

	1	2	3	4	5	6	7	8	9	10	11		
	DOOR SCHEDULE												
ID	NOMINAL WIDTH	NOMINAL HEIGHT	DOOR THICKNESS	DOOR MATL	DOOR TYPE	Frame Material	Frame Type	Hardware Set	HEAD	JAMB	Sill Type	Fire Resistance Rating	REMARKS
01.1	2'-8"	7'-0"	1 3/4"	HM	A	HM	1	1				Unrated	
01.2	3'-0"	7'-0"	1 3/4"	WOOD	A	WD	2	3				Unrated	
01.3	2'-0"	7'-0"	1 3/4"	WOOD	A	WD	2	3				Unrated	
01.4	2'-10"	7'-0"	1 3/4"	HM	A	HM	3	1				20 minutes	
01.5	3'-0"	7'-0"	1 3/4"	HM	A	HM	1	1				Unrated	
02.1	2'-10"	7'-0"	1 3/4"	HM	A	HM	1	1				Unrated	
02.2	2'-6"	7'-0"	1 3/4"	WOOD	A	WD	2	3				Unrated	
02.3	4'-8"	6'-8"	1 3/4"	WOOD	A	WD	2	3				Unrated	PR 2'-4"
02.4	2'-10"	7'-0"	1 3/4"	HM	A	HM	3	1				20 minutes	
02.5	2'-8"	7'-0"	1 3/4"	WOOD	A	WD	2	3				Unrated	
03.1	2'-10"	7'-0"	1 3/4"	HM	A	HM	1	1				Unrated	
03.2	2'-6"	7'-0"	1 3/4"	WOOD	A	WD	2	3				Unrated	
03.3	4'-8"	6'-8"	1 3/4"	WOOD	A	WD	2	3				Unrated	PR 2'-4"
03.4	2'-10"	7'-0"	1 3/4"	HM	A	HM	3	1				20 minutes	
03.5	2'-8"	7'-0"	1 3/4"	WOOD	A	WD	2	3				Unrated	
04.1	2'-10"	7'-0"	1 3/4"	HM	A	HM	1	1				Unrated	
04.2	2'-6"	7'-0"	1 3/4"	WOOD	A	WD	2	3				Unrated	
04.3	4'-8"	6'-8"	1 3/4"	WOOD	A	WD	2	3				Unrated	PR 2'-4"
04.4	2'-10"	7'-0"	1 3/4"	HM	A	HM	3	1				20 minutes	
04.5	2'-8"	7'-0"	1 3/4"	WOOD	A	WD	2	3				Unrated	
06	ETR	ETR	ETR	HM	A	HM	3	1				Unrated	PR 3'-0" & 2'-0"
07	6'-0"	7'-0"	1 3/4"	HM	A	HM	3	4				15 hours	PR 3'-0"
08	3'-0"	7'-0"	1 3/4"	HM	A	HM	3	4				20 minutes	
11	3'-0"	7'-0"	1 3/4"	Undefined	--	HM	1	2				2 hours	EXISTING DOOR, REVERSE SWING
12	3'-0"	7'-0"	1 3/4"	HM	A	HM	3	4				2 hours	
14.1	3'-0"	7'-0"	1 3/4"	ALUM / GL	C	ALUM	2	2				Unrated	
14.2	3'-0"	7'-0"	1 3/4"	WOOD	A	WD	2	4				Unrated	
101.2	2'-6"	6'-8"	1 3/4"	WOOD	A	WD	2	3				Unrated	
101.3	5'-0"	6'-8"	1 3/4"	WOOD	A	WD	2	5				Unrated	PR 2'-6" SLIDING
102.2	2'-6"	6'-8"	1 3/4"	WOOD	A	WD	2	3				Unrated	
102.3	5'-0"	6'-8"	1 3/4"	WOOD	A	WD	2	5				Unrated	PR 2'-6" SLIDING
103.2	2'-6"	6'-8"	1 3/4"	WOOD	A	WD	2	3				Unrated	
103.3	5'-0"	6'-8"	1 3/4"	WOOD	A	WD	1	5				Unrated	PR 2'-6" SLIDING
104.1	3'-0"	7'-0"	1 3/4"	WOOD	A	WD	2	1				20 minutes	
104.3	2'-6"	6'-8"	1 3/4"	WOOD	A	WD	2	3				Unrated	
104.4	5'-0"	6'-8"	1 3/4"	WOOD	A	WD	2	5				Unrated	PR 2'-6" SLIDING
105.1	3'-0"	7'-0"	1 3/4"	WOOD	A	WD	2	1				20 minutes	
105.2	2'-0"	6'-8"	1 3/4"	WOOD	A	WD	2	1				20 minutes	
105.3	2'-6"	6'-8"	1 3/4"	WOOD	A	WD	2	3				Unrated	
105.4	4'-0"	7'-0"	1 3/4"	WOOD	A	WD	2	5				Unrated	PR 2'-0" SLIDING
106	2'-10"	7'-0"	1 3/4"	HM	B	HM	1	1				Unrated	
108	3'-0"	7'-0"	1 3/4"	HM	A	HM	1	2				15 hours	
109.1	3'-0"	7'-0"	1 3/4"	ALUM / GL	C	ALUM	1	1				Unrated	
109.2	3'-0"	7'-0"	1 3/4"	ALUM / GL	C	ALUM	2	1				Unrated	CARD READER LOCKSET
109.3	ETR	ETR	ETR	ETR	--	ETR	ETR	1				15 hours	CARD READER LOCKSET
110.1	3'-0"	7'-0"	1 3/4"	ALUM / GL	C	ALUM	1	1				Unrated	
110.2	3'-2"	7'-0"	0"	--	CASED OPNG	WD	2	--				Unrated	
110.3	3'-0"	6'-8"	1 3/4"	WOOD	A	HM	2	4				20 minutes	
110.3	3'-0"	7'-0"	1 3/4"	WOOD	A	WD	2	1				20 minutes	
110.4	2'-6"	6'-8"	1 3/4"	WOOD	A	WD	2	1				Unrated	
111	3'-0"	7'-0"	1 3/4"	WOOD	A	HM	2	4				20 minutes	
201.1	2'-6"	7'-0"	0"	--	CASED OPNG	WD	2	--				Unrated	
201.2	3'-0"	7'-0"	1 3/4"	WOOD	A	WD	2	3				Unrated	
201.3	2'-6"	7'-0"	1 3/4"	WOOD	A	WD	2	3				Unrated	
202.1	2'-6"	7'-0"	0"	--	CASED OPNG	WD	2	--				Unrated	
202.2	3'-0"	7'-0"	1 3/4"	WOOD	A	WD	2	3				Unrated	
202.3	2'-6"	7'-0"	1 3/4"	WOOD	A	WD	2	3				Unrated	
203.1	2'-6"	7'-0"	0"	--	CASED OPNG	WD	2	--				Unrated	
203.2	3'-0"	7'-0"	1 3/4"	WOOD	A	WD	2	3				Unrated	
203.3	2'-6"	7'-0"	1 3/4"	WOOD	A	WD	2	3				Unrated	
204.1	2'-6"	7'-0"	0"	--	CASED OPNG	WD	2	--				Unrated	
204.2	3'-0"	7'-0"	1 3/4"	WOOD	A	WD	2	3				Unrated	
204.3	2'-6"	7'-0"	1 3/4"	WOOD	A	WD	2	3				Unrated	
204.4	3'-0"	7'-0"	1 3/4"	WOOD	A	WD	2	1				20 minutes	
204.5	2'-6"	7'-0"	1 3/4"	WOOD	A	WD	2	3				Unrated	
204.6	2'-6"	7'-0"	1 3/4"	WOOD	A	WD	2	3				Unrated	
205.1	2'-6"	7'-0"	0"	--	CASED OPNG	WD	2	--				Unrated	
205.2	3'-0"	7'-0"	1 3/4"	WOOD	A	WD	2	3				Unrated	
205.3	2'-6"	7'-0"	1 3/4"	WOOD	A	WD	2	3				Unrated	
206.1	2'-6"	7'-0"	0"	--	CASED OPNG	WD	2	--				Unrated	
206.2	3'-0"	7'-0"	1 3/4"	WOOD	A	WD	2	3				Unrated	
206.3	2'-6"	7'-0"	1 3/4"	WOOD	A	WD	2	3				Unrated	
207.1	2'-6"	7'-0"	0"	--	CASED OPNG	WD	2	--				Unrated	
207.2	3'-0"	7'-0"	1 3/4"	WOOD	A	WD	2	3				Unrated	
207.3	2'-6"	7'-0"	1 3/4"	WOOD	A	WD	2	3				Unrated	
209	3'-0"	7'-0"	1 3/4"	HM	A	HM	1	2				15 hours	
210	2'-10"	7'-0"	1 3/4"	HM	B	HM	1	1				Unrated	
301.1	2'-6"	7'-0"	0"	--	CASED OPNG	WD	2	--				Unrated	
301.1	2'-6"	7'-0"	0"	--	CASED OPNG	WD	2	--				Unrated	
301.2	3'-0"	7'-0"	1 3/4"	WOOD	A	WD	2	3				Unrated	
301.2	3'-0"	7'-0"	1 3/4"	WOOD	A	WD	2	3				Unrated	
301.3	2'-6"	7'-0"	1 3/4"	WOOD	A	WD	2	3				Unrated	
301.3	2'-6"	7'-0"	1 3/4"	WOOD	A	WD	2	3				Unrated	
303.1	2'-6"	7'-0"	0"	--	CASED OPNG	WD	2	--				Unrated	
303.2	3'-0"	7'-0"	1 3/4"	WOOD	A	WD	2	3				Unrated	
303.3	2'-6"	7'-0"	1 3/4"	WOOD	A	WD	2	3				Unrated	
	1	2	3	4	5	6	7	8	9	10	11		

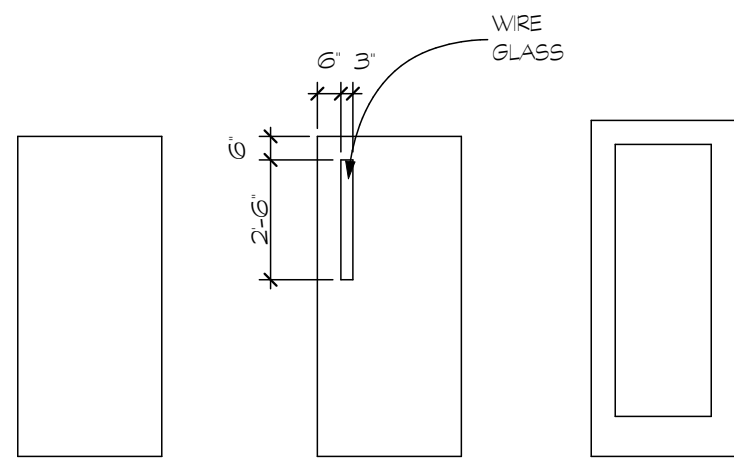
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DOOR SCHEDULE													
ID	NOMINAL WIDTH	NOMINAL HEIGHT	DOOR THICKNESS	DOOR MATL	DOOR TYPE	Frame Material	Frame Type	Hardware Set	HEAD	JAMB	Sill Type	Fire Resistance Rating	REMARKS
303.3	2'-6"	7'-0"	1 3/4"	WOOD	A	WD	2	3				Unrated	
304.1	2'-6"	7'-0"	0"	---	CASED OPNG	WD	2	--				Unrated	
304.2	3'-0"	7'-0"	1 3/4"	WOOD	A	WD	2	3				Unrated	
304.3	2'-6"	7'-0"	1 3/4"	WOOD	A	WD	2	3				Unrated	
304.4	3'-0"	7'-0"	1 3/4"	WOOD	A	WD	2	3				Unrated	
304.5	2'-6"	7'-0"	1 3/4"	WOOD	A	WD	2	3				Unrated	
304.6	2'-6"	7'-0"	1 3/4"	WOOD	A	WD	2	3				Unrated	
305.1	2'-6"	7'-0"	0"	---	CASED OPNG	WD	2	--				Unrated	
305.2	3'-0"	7'-0"	1 3/4"	WOOD	A	WD	2	3				Unrated	
305.3	2'-6"	7'-0"	1 3/4"	WOOD	A	WD	2	3				Unrated	
306.1	2'-6"	7'-0"	0"	---	CASED OPNG	WD	2	--				Unrated	
306.2	3'-0"	7'-0"	1 3/4"	WOOD	A	WD	2	3				Unrated	
306.3	2'-6"	7'-0"	1 3/4"	WOOD	A	WD	2	3				Unrated	
307.1	2'-6"	7'-0"	0"	---	CASED OPNG	WD	2	--				Unrated	
307.2	2'-8"	7'-0"	1 3/4"	WOOD	A	WD	2	3				Unrated	
307.3	2'-6"	7'-0"	1 3/4"	WOOD	A	WD	2	3				Unrated	
309	3'-0"	7'-0"	1 3/4"	HM	A	HM	1	2				15 hours	
310	2'-10"	7'-0"	1 3/4"	HM	B	HM	1	1				Unrated	
401	2'-10"	7'-0"	1 3/4"	HM	A	HM	1	6				15 hours	

HARDWARE SET FUNCTION

1. ENTRANCE LOCK
2. PASSIVE
3. BATHROOM LOCK
4. STOREROOM
5. SLIDING DOOR LOCK
6. CARD ACCESS

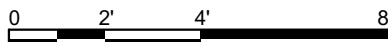


FRAME TYPES



DOOR ELEVATIONS

5 DOORS & FRAMES
SCALE: 1/4" = 1'-0"



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KAVANAUGH BUILDING RENOVATIONS

HARRISONBURG, VIRGINIA

DATE	REVISION
2/3/2021	LAUNDRY RM
3/26/21	REISSUED



PROJECT NUMBER:	SCALE:
2017.0086	AS NOTED
PROJECT MANAGER:	CHECKED BY:
DRAWN BY:	DATE:
	12/21/2020
DRAWING TITLE:	
DOOR SCHEDULE	

A1.5

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KAVANAUGH BUILDING RENOVATIONS

HARRISONBURG, VIRGINIA

DATE	REVISION
3/9/21	REISSUED
3/26/21	REISSUED



PROJECT NUMBER:	SCALE:
2017.0086	AS NOTED
PROJECT MANAGER:	CHECKED BY:
DRAWN BY:	DATE:
	12/21/2020
DRAWING TITLE:	
EAST & WEST ELEVATIONS	

A2.1

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KAVANAUGH BUILDING RENOVATIONS

HARRISONBURG, VIRGINIA

DATE	REVISION
3/9/21	REISSUED
3/26/21	REISSUED



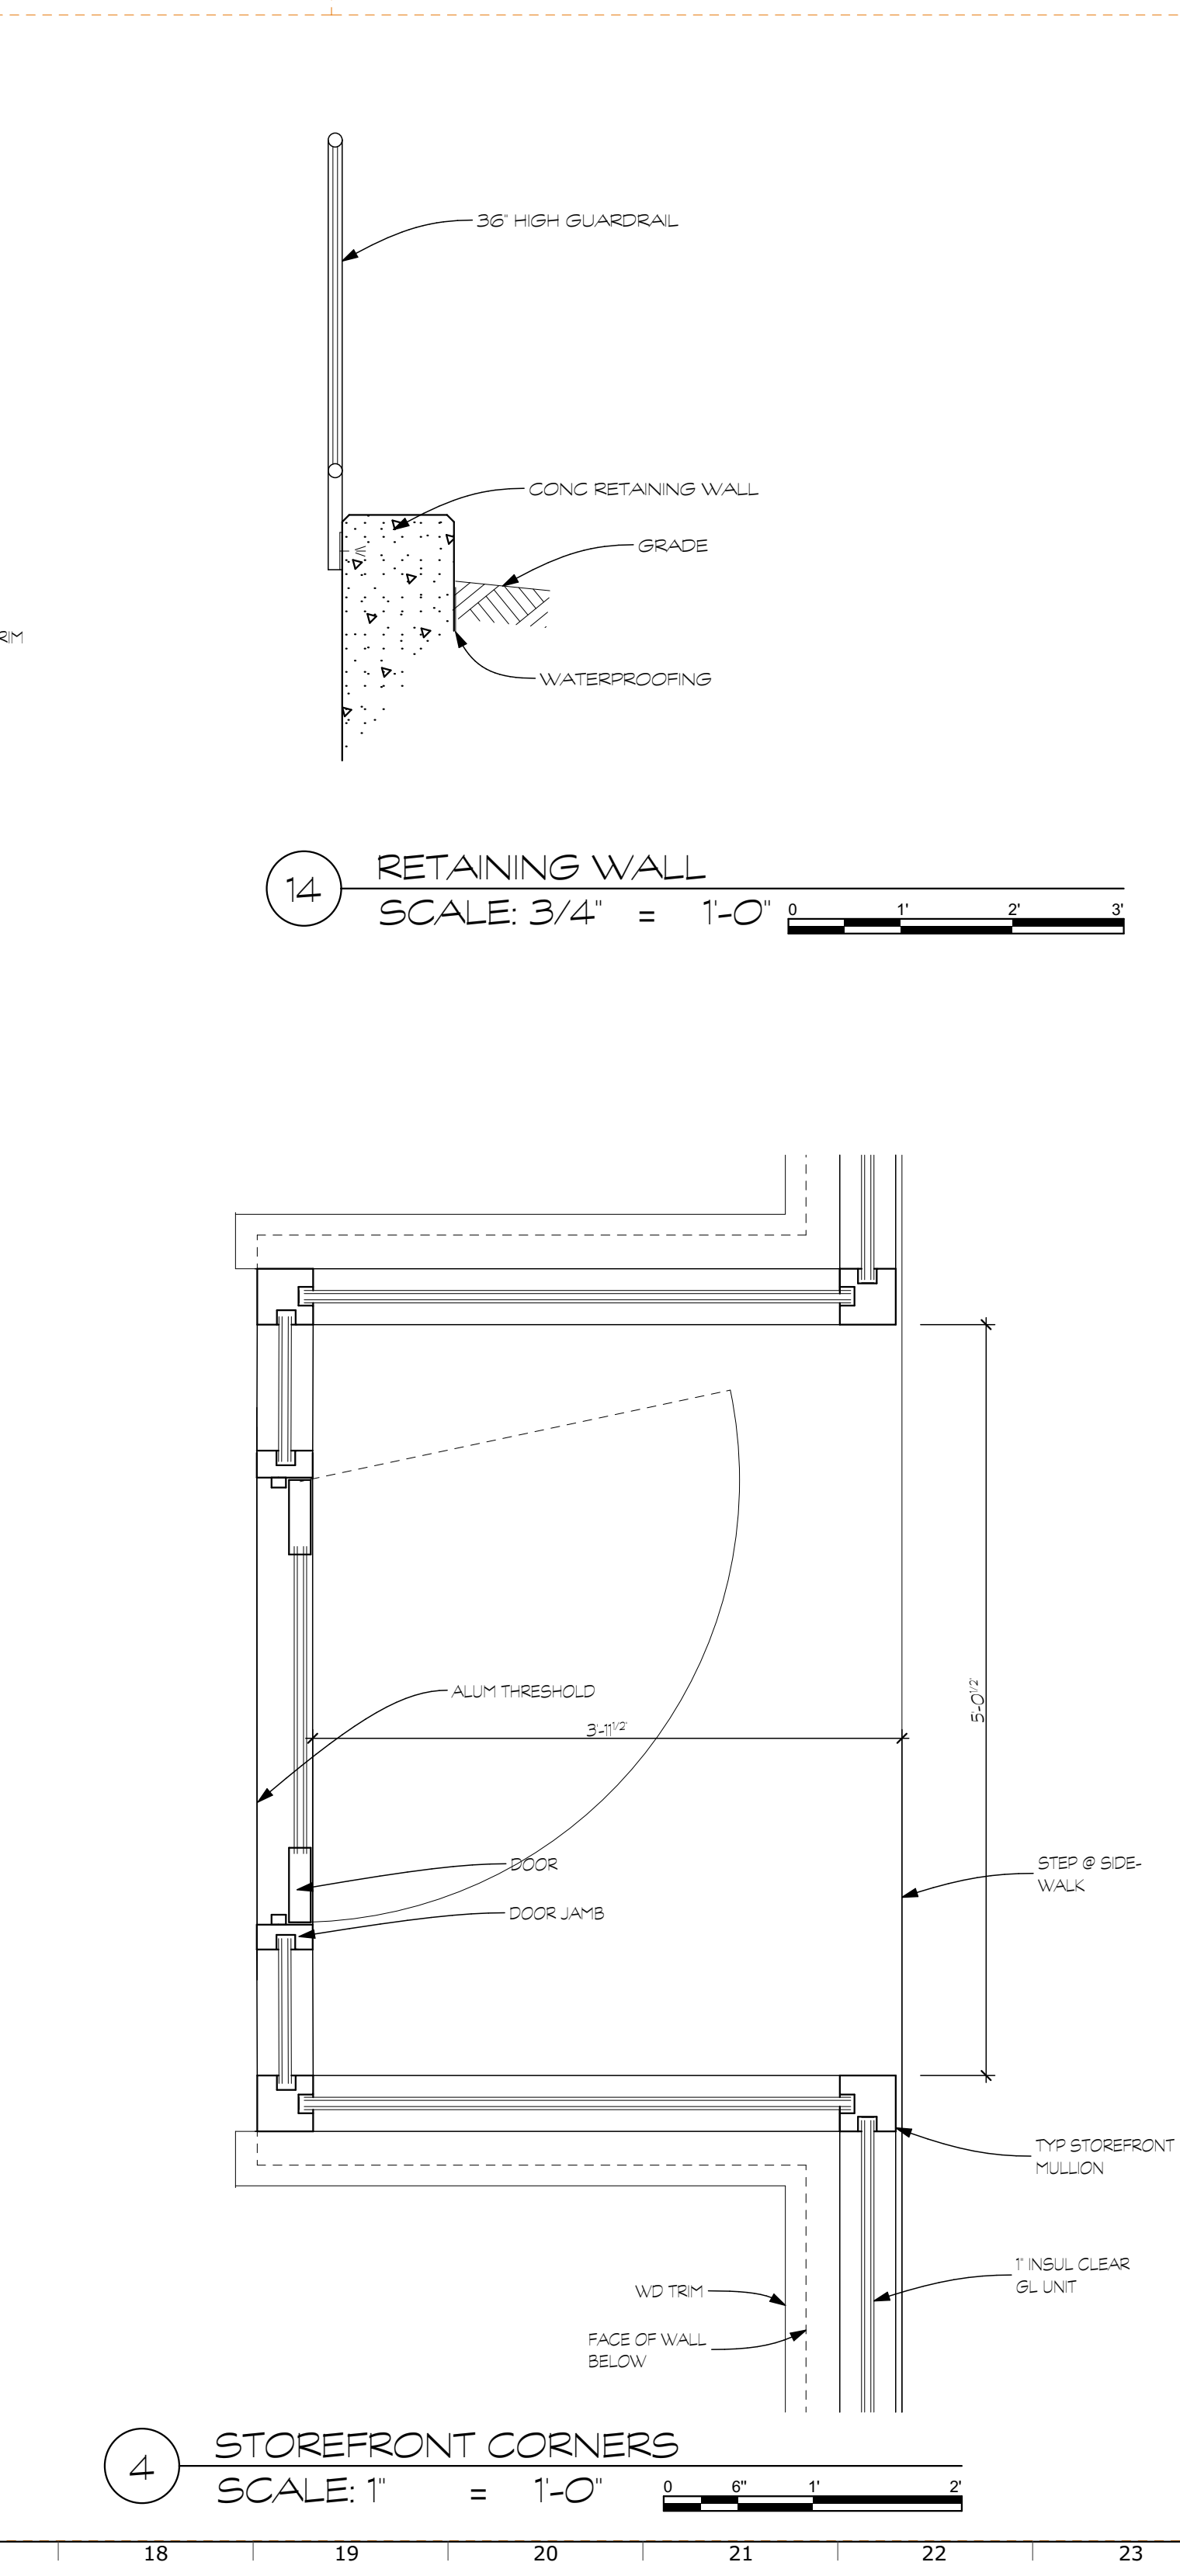
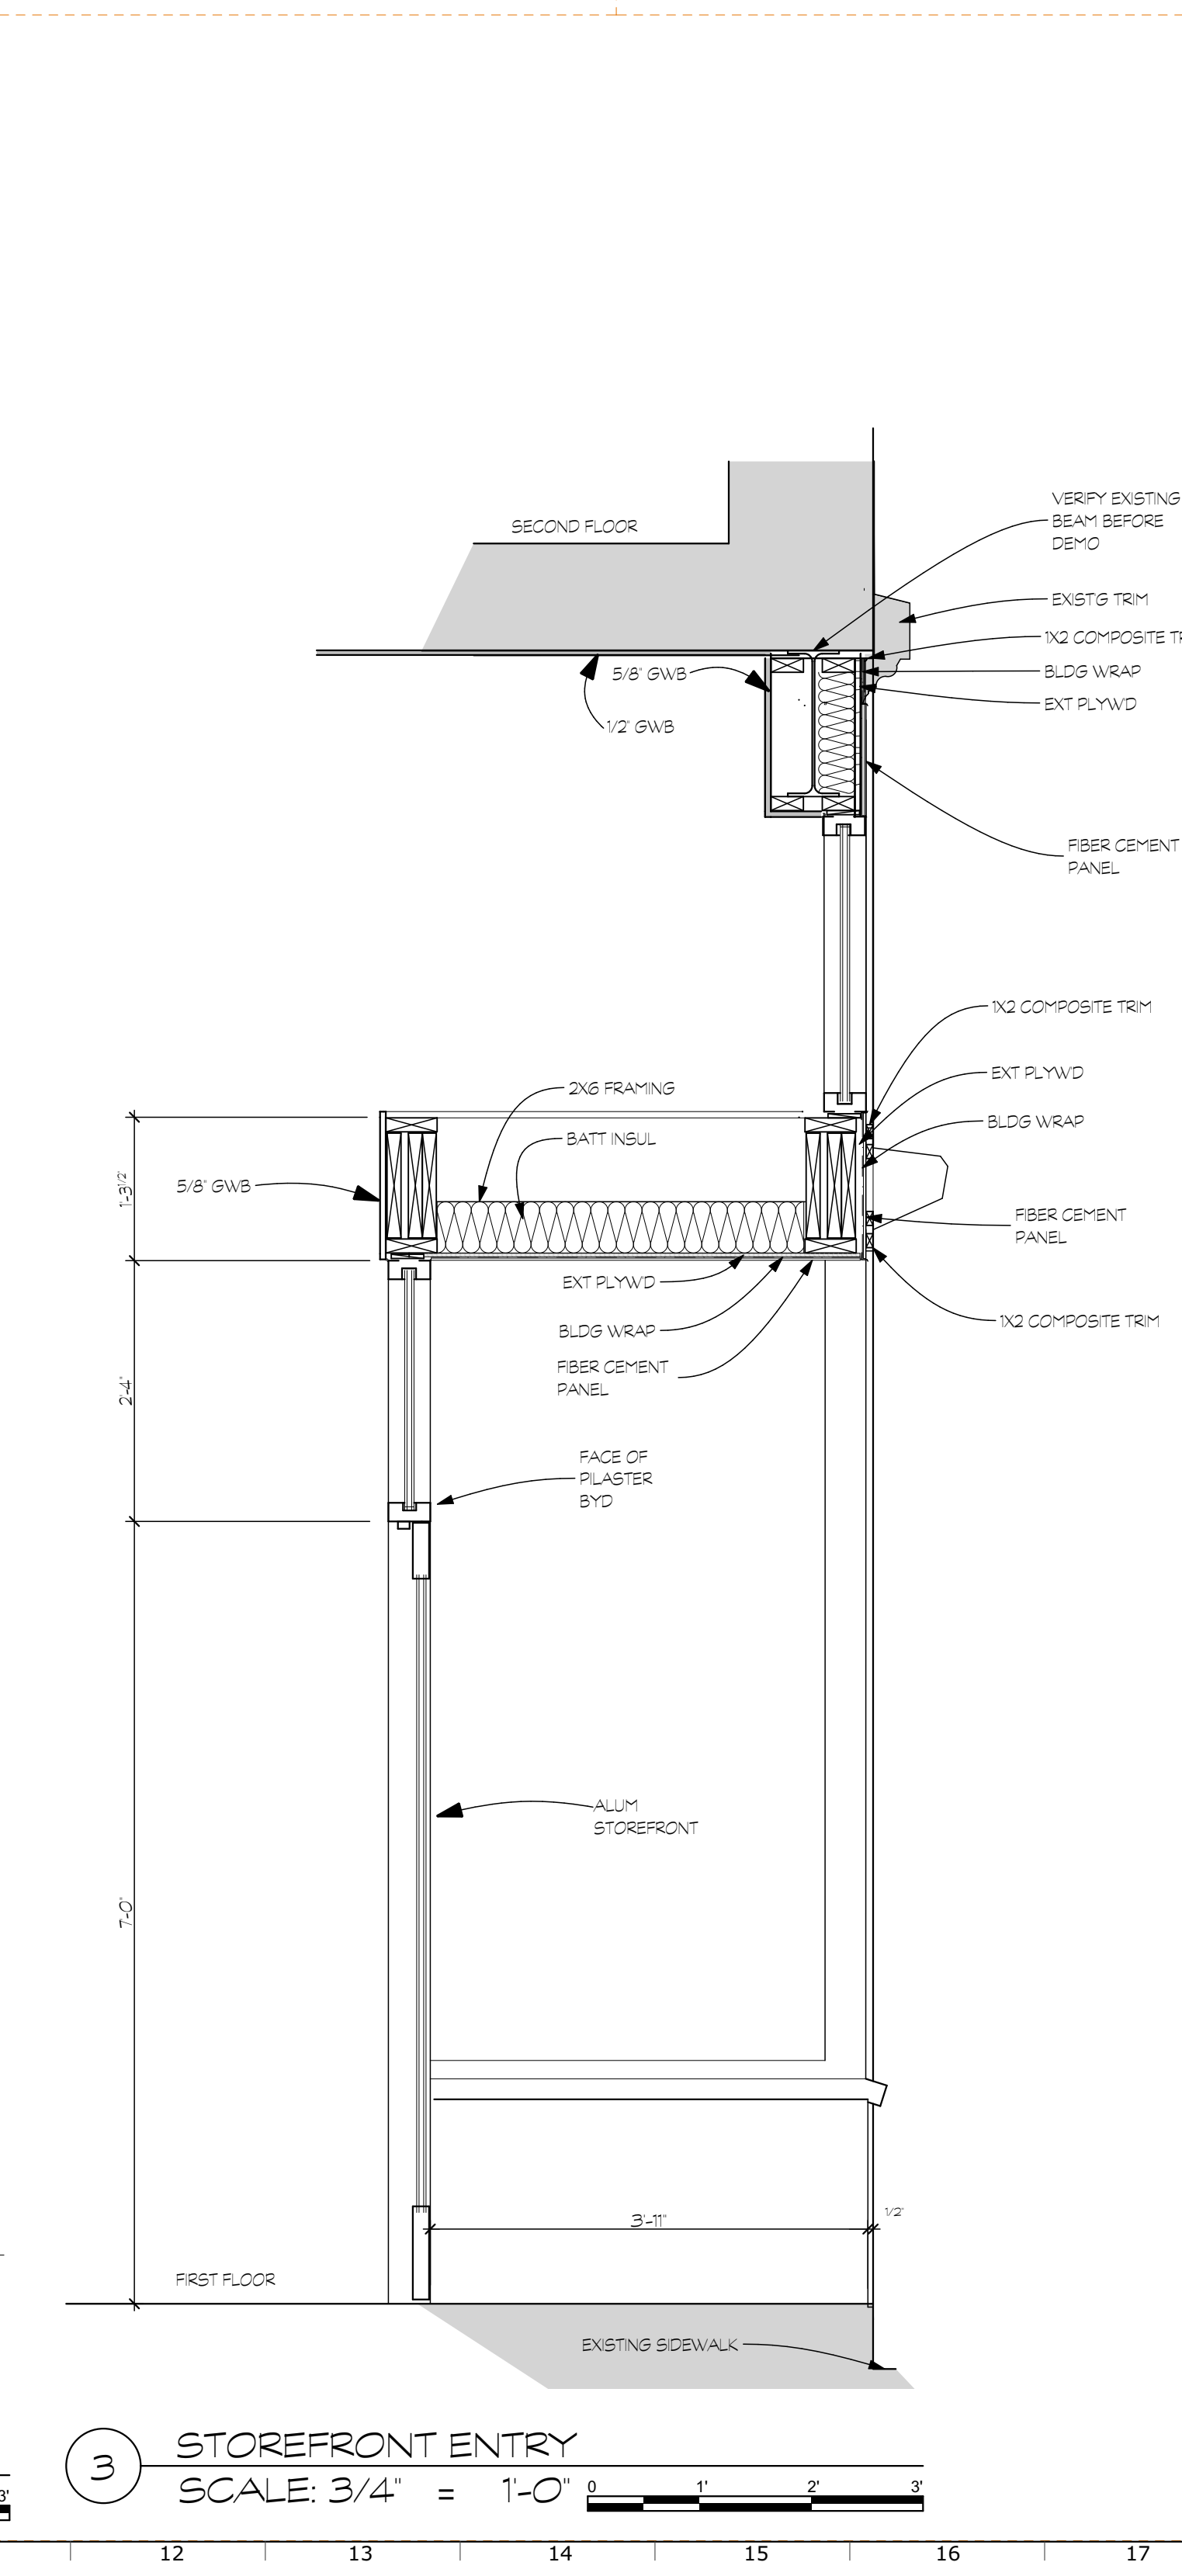
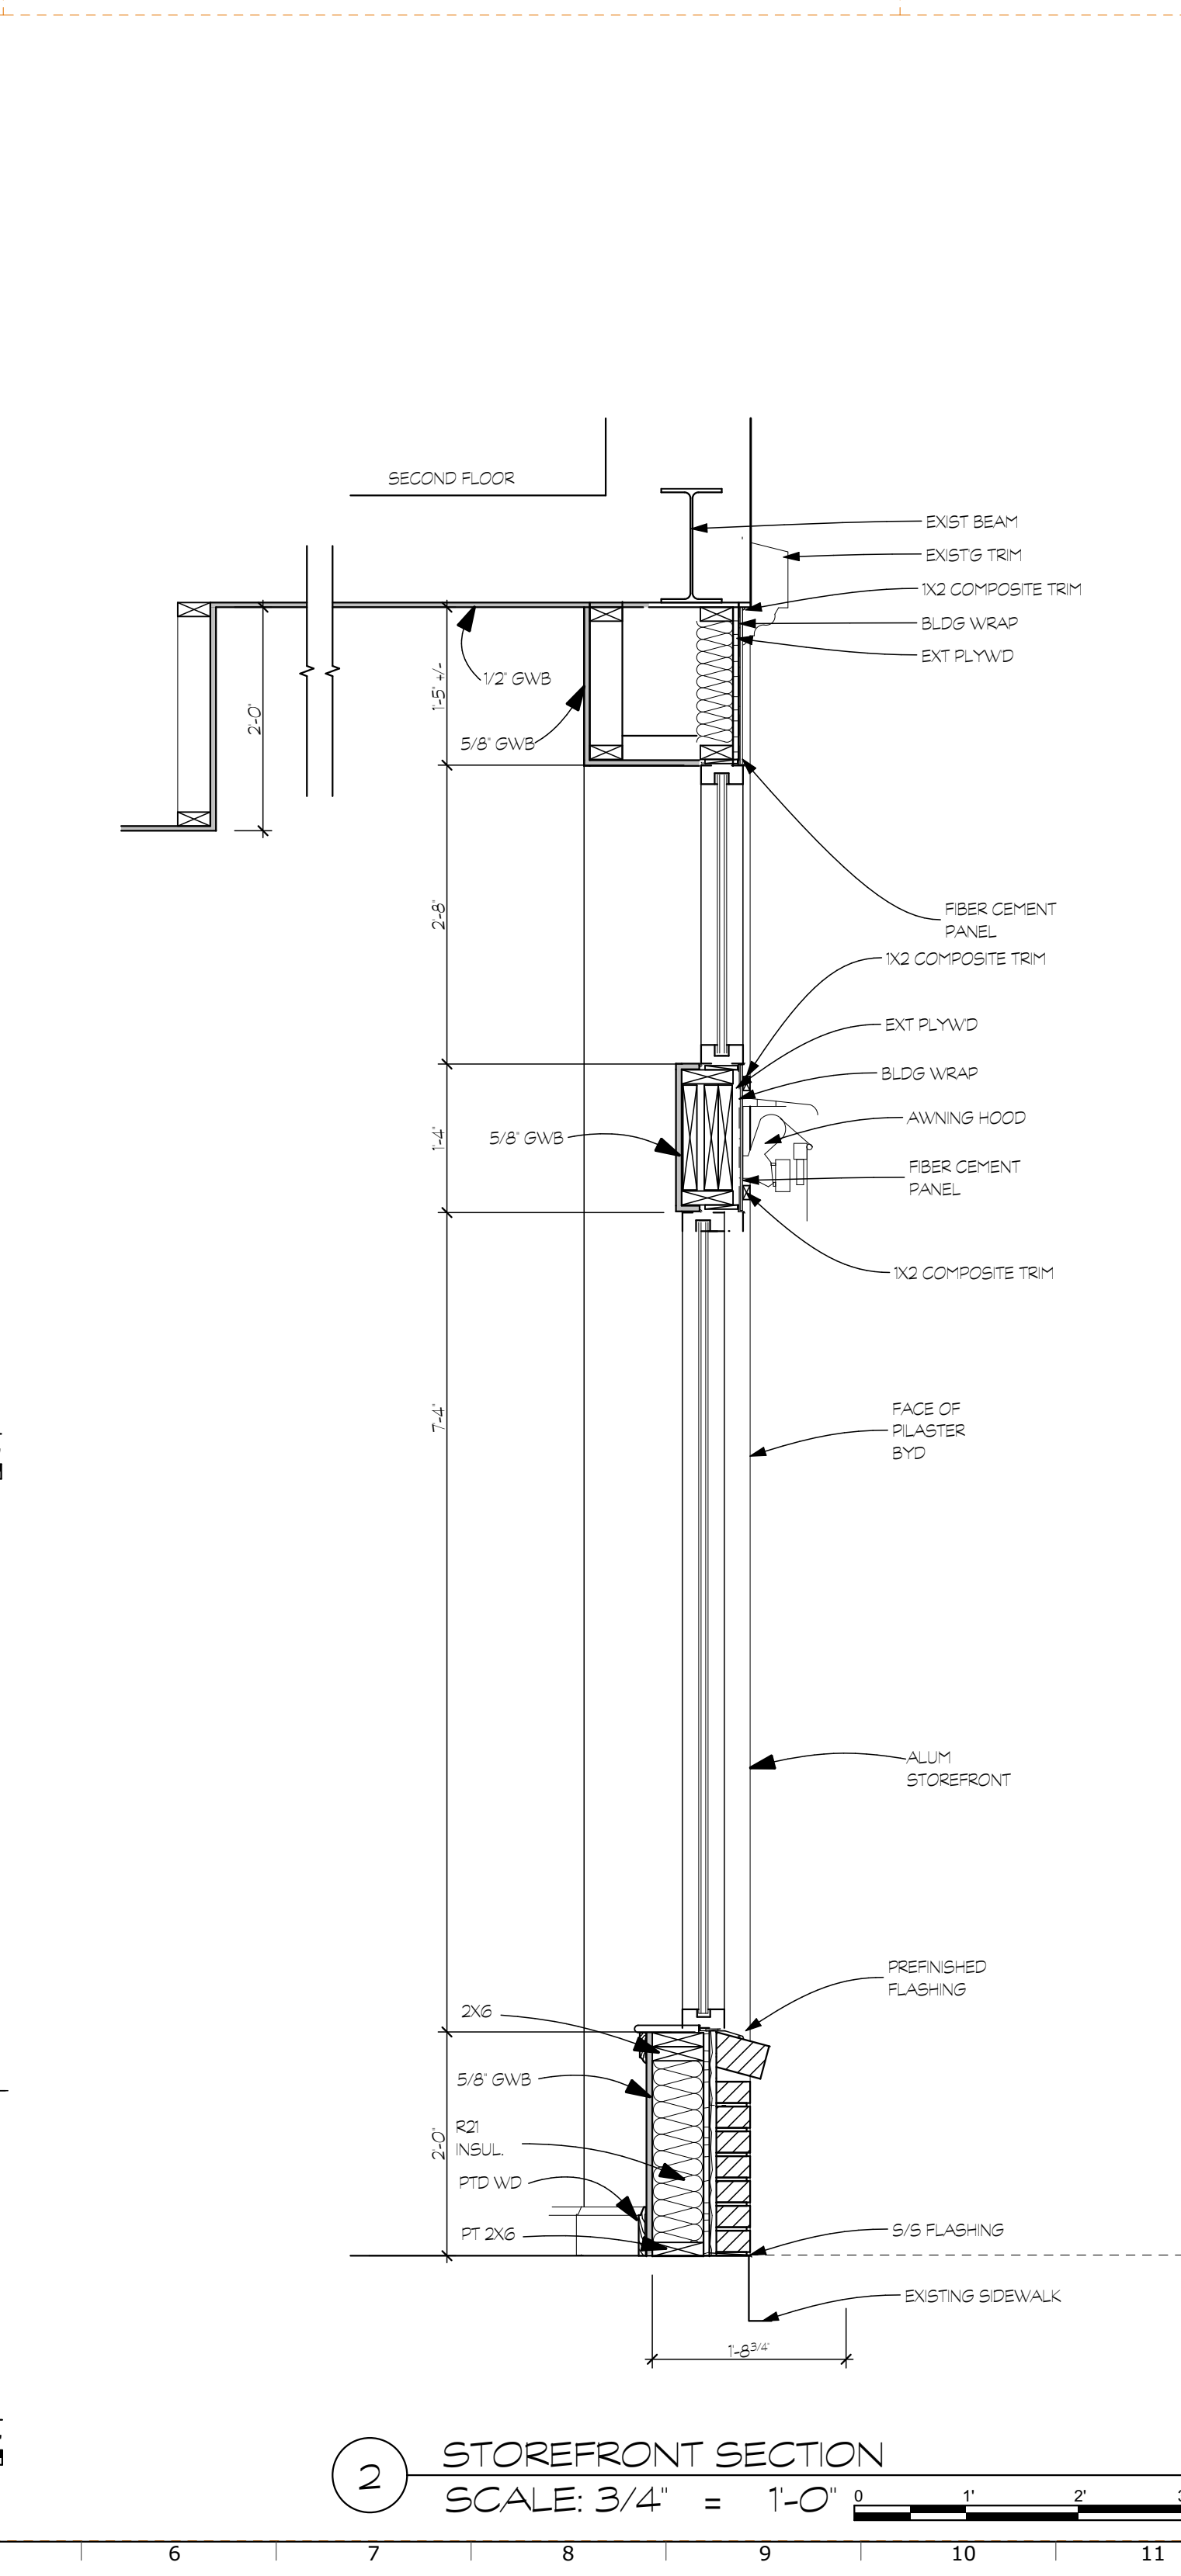
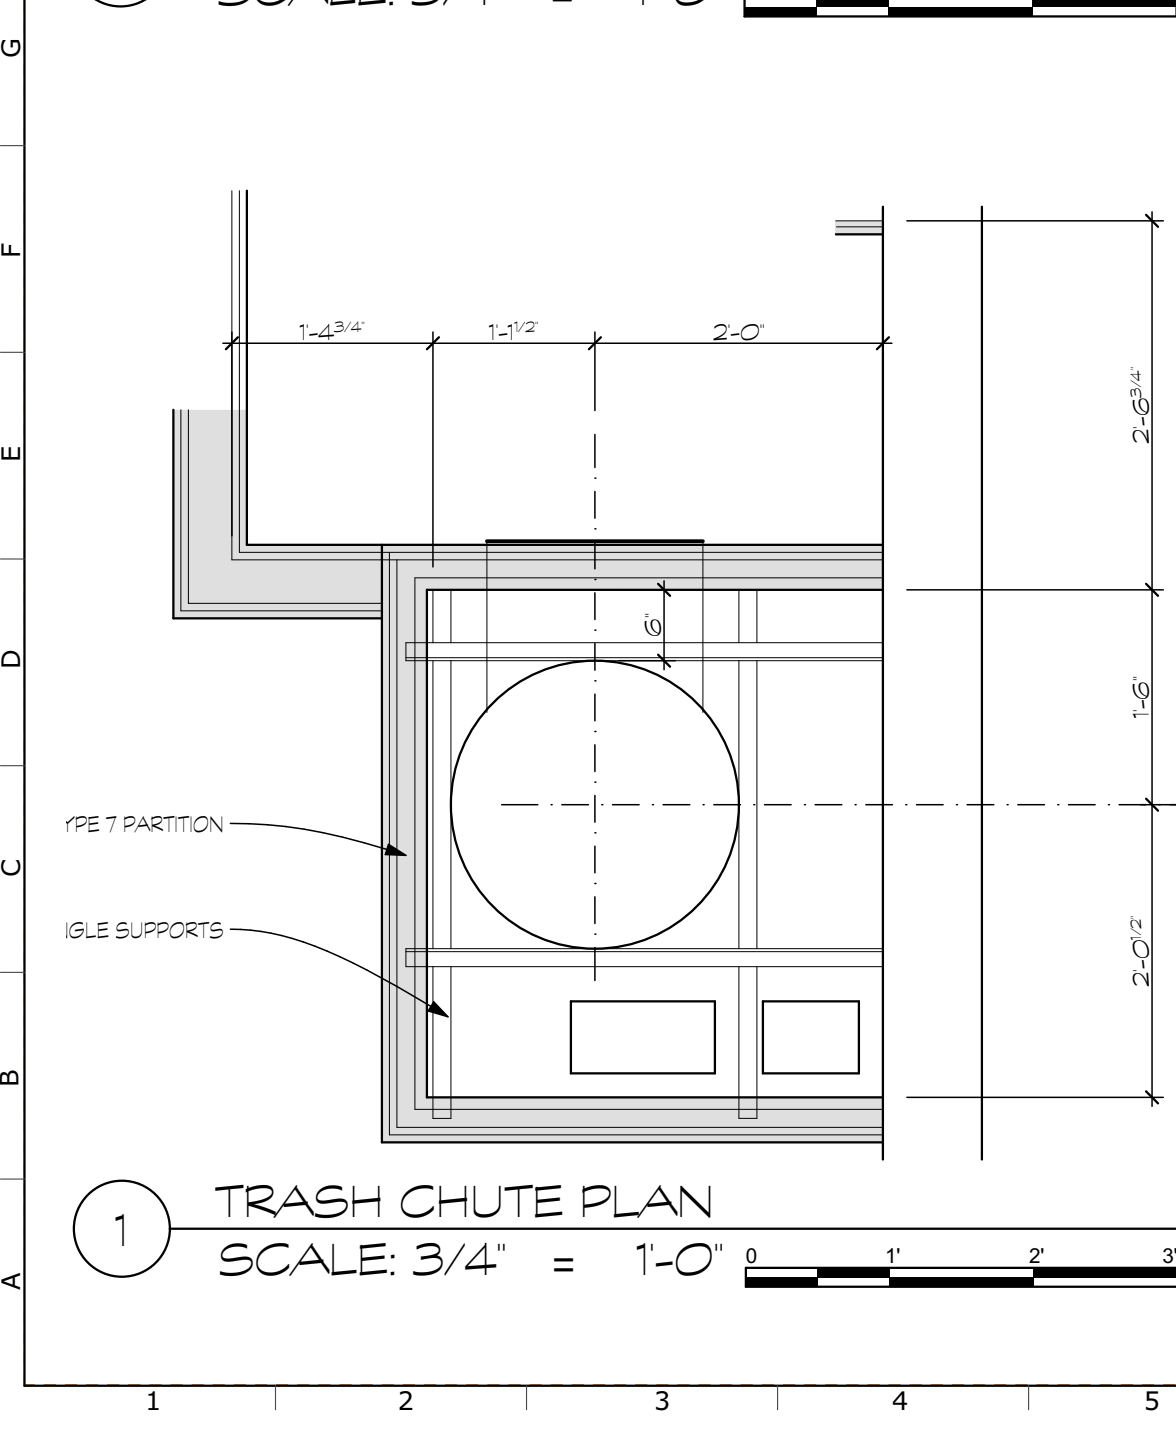
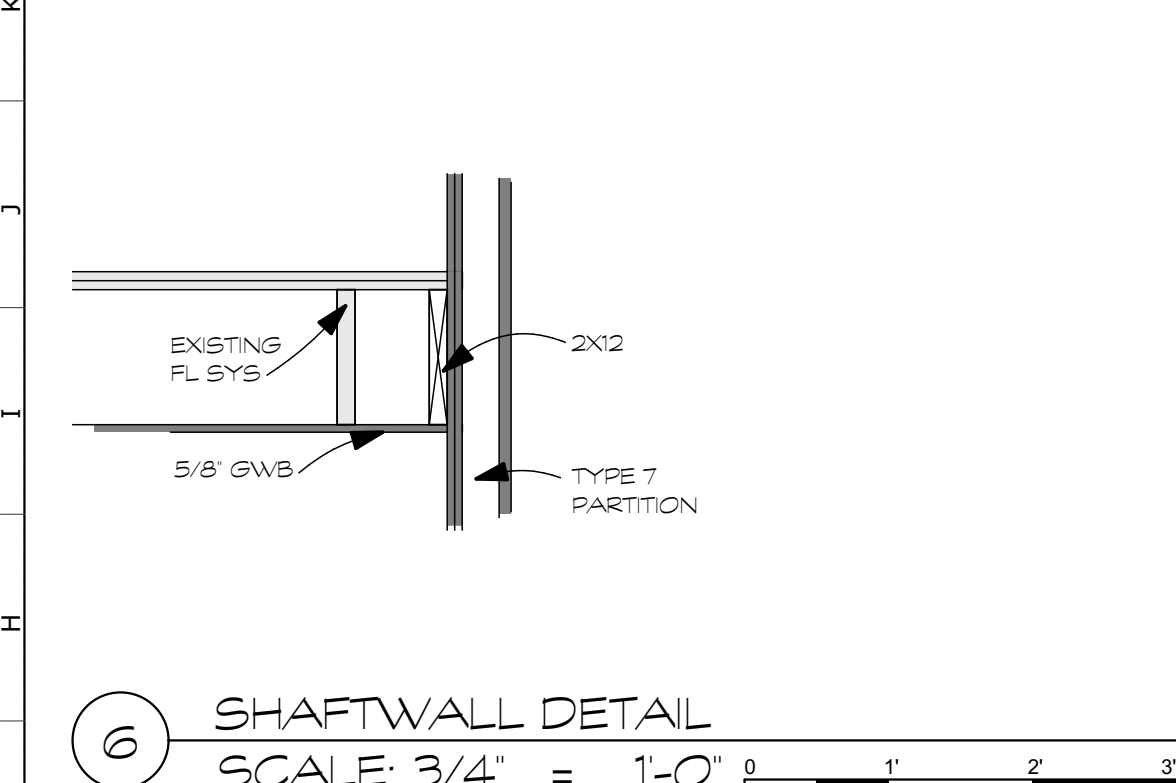
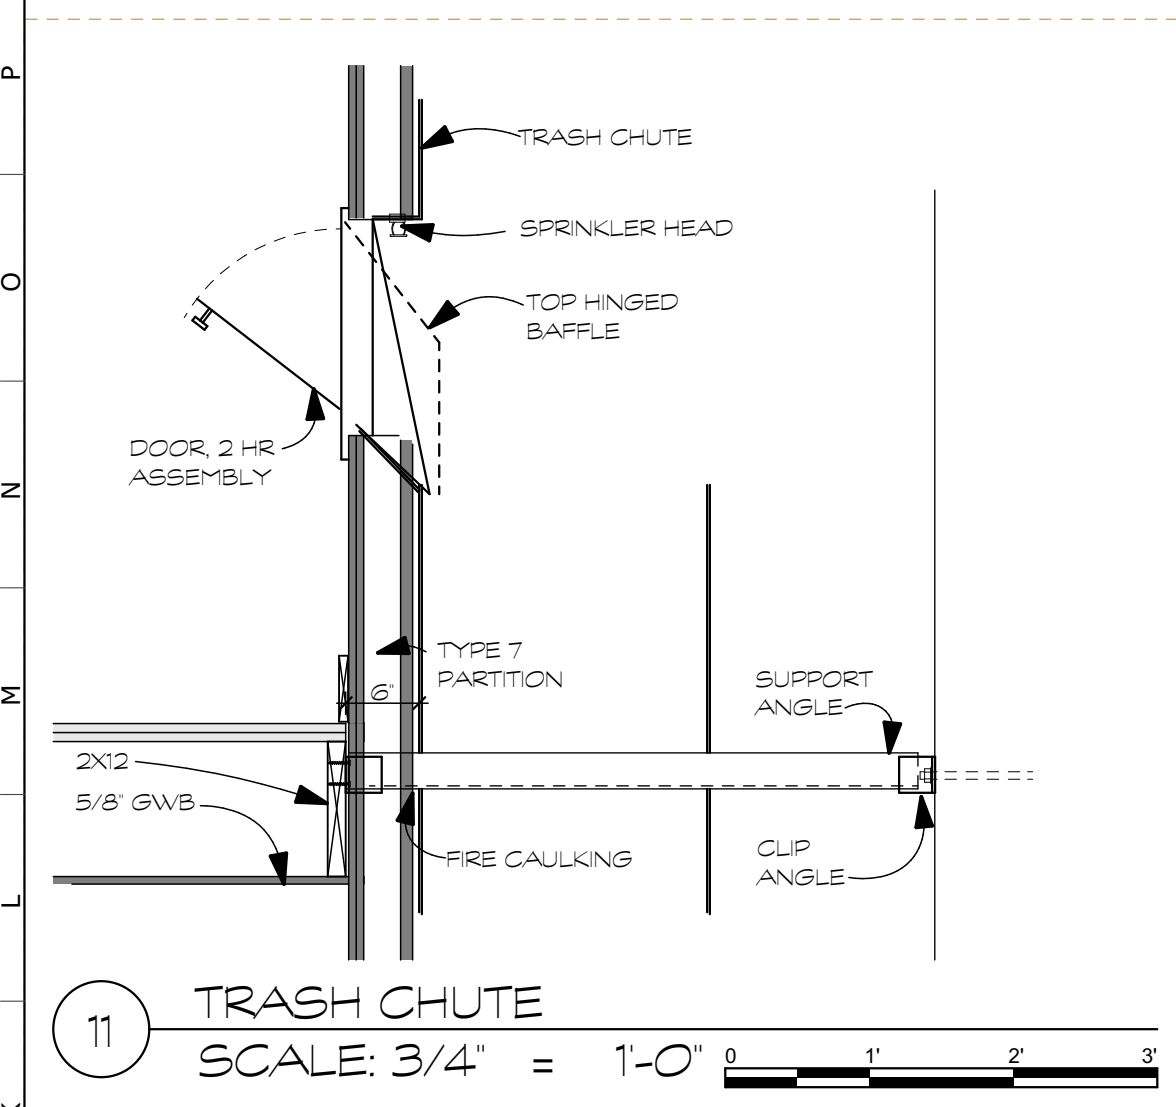
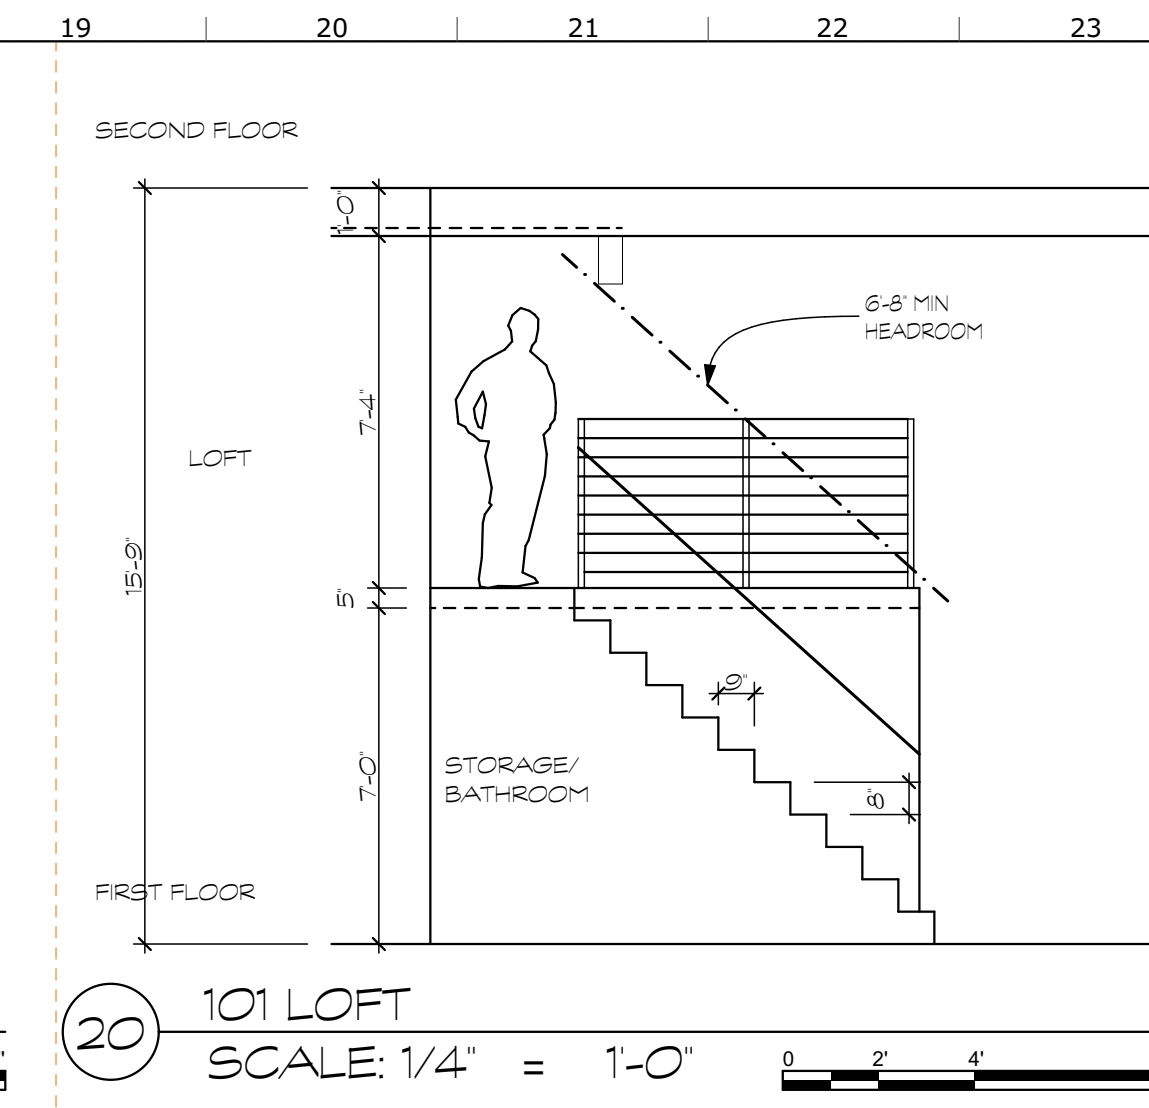
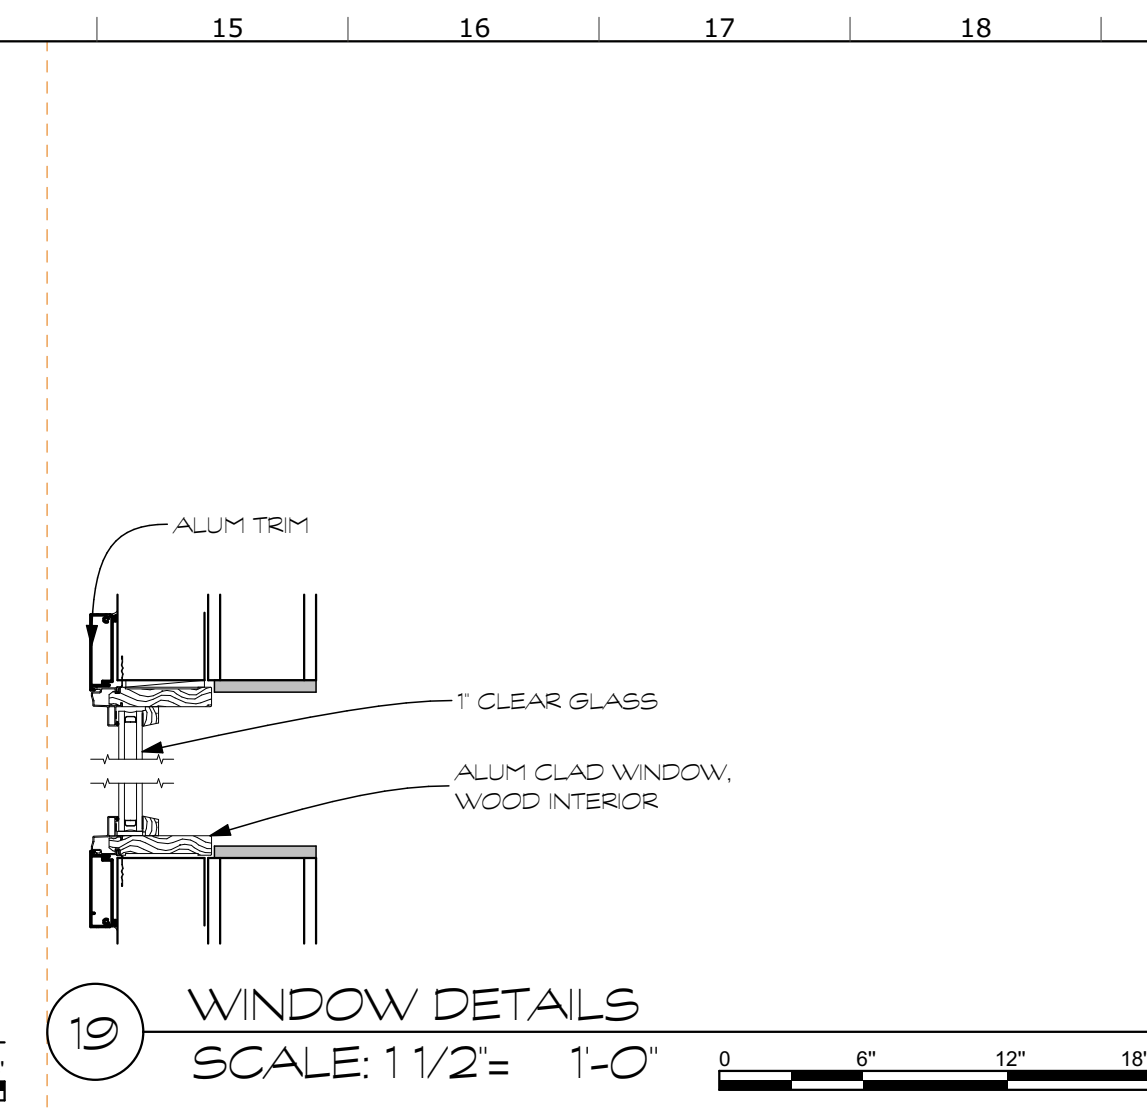
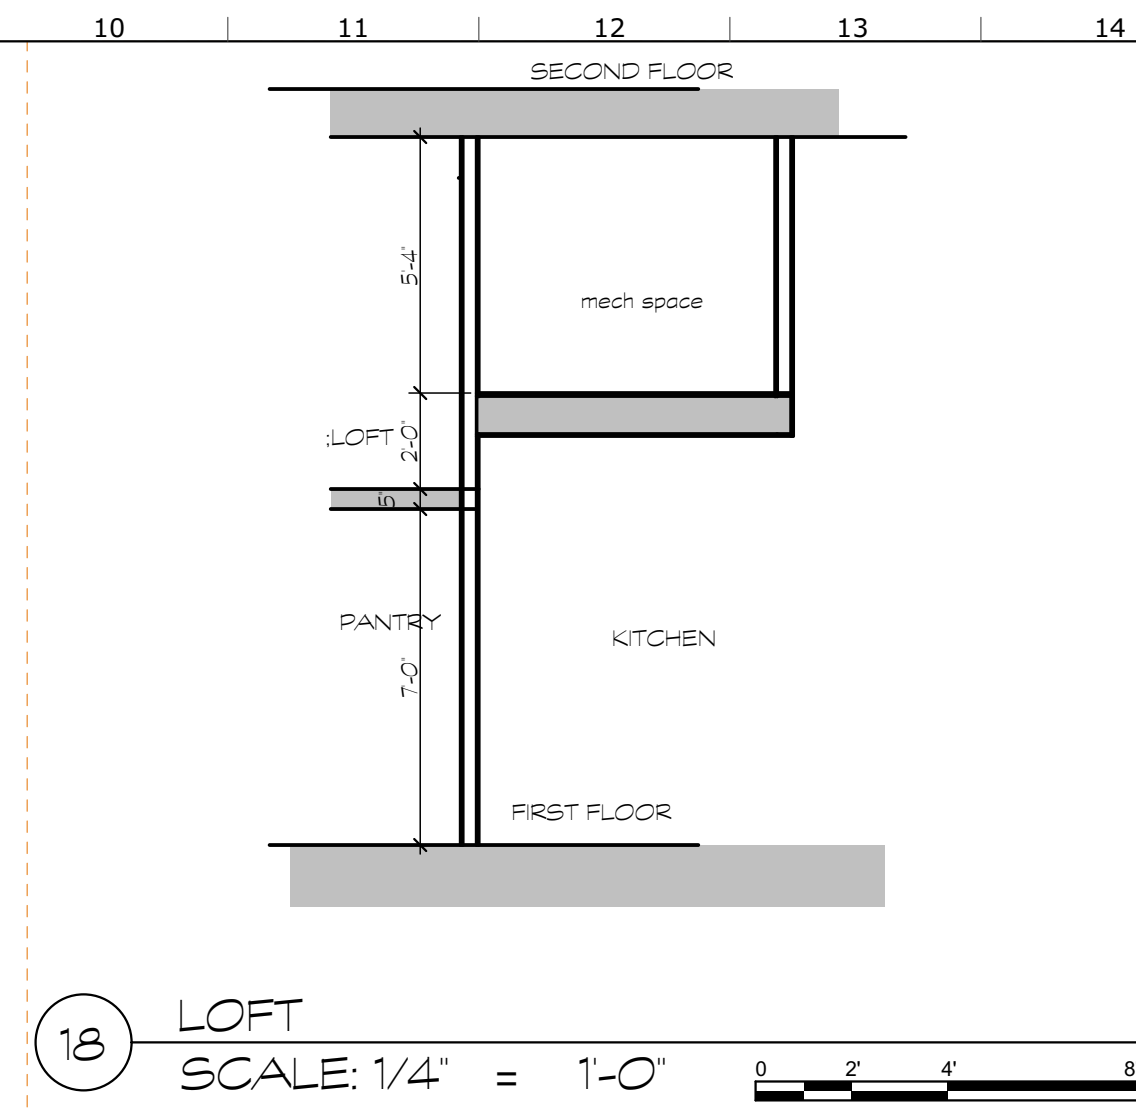
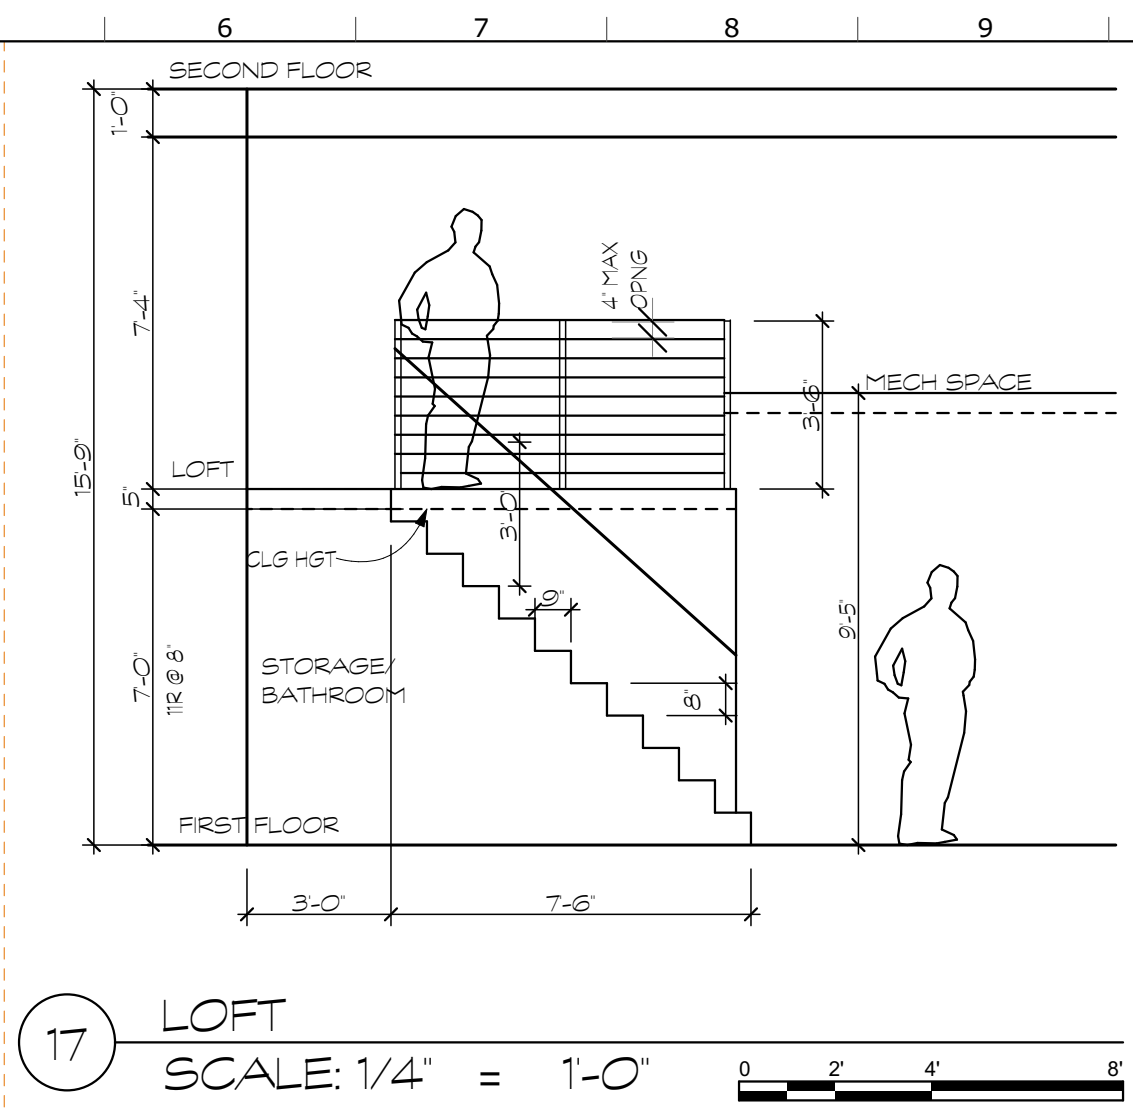
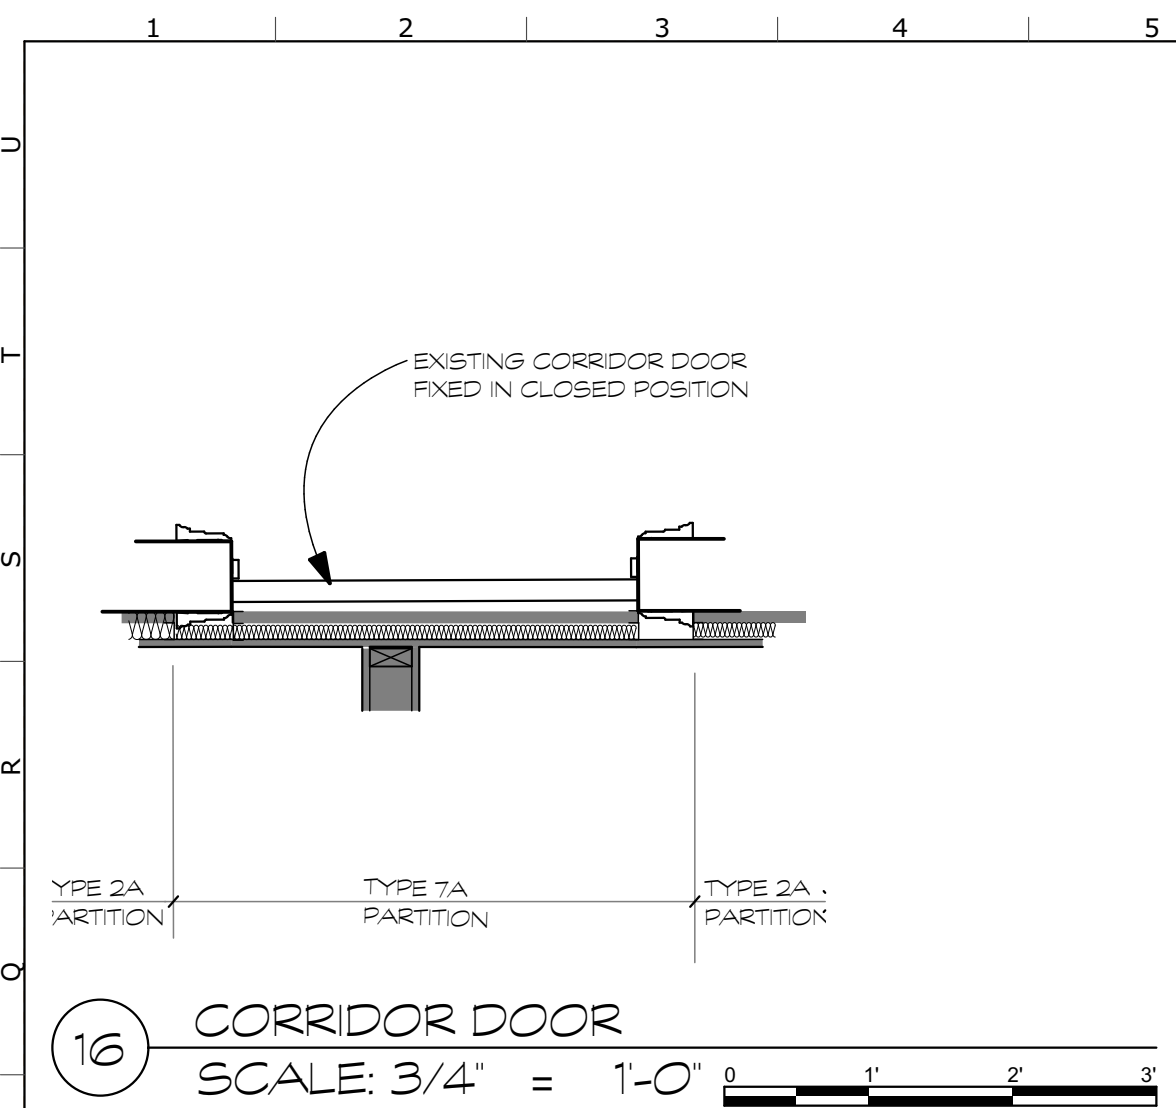
PROJECT NUMBER: 2017.0086	SCALE: AS NOTED
PROJECT MANAGER:	CHECKED BY:
DRAWN BY:	DATE: 12/21/2020

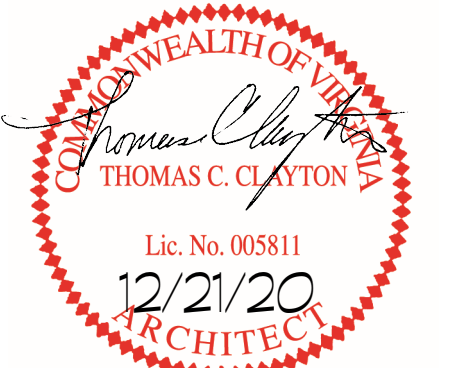
DRAWING TITLE:
SOUTH ELEVATIONS

A2.2

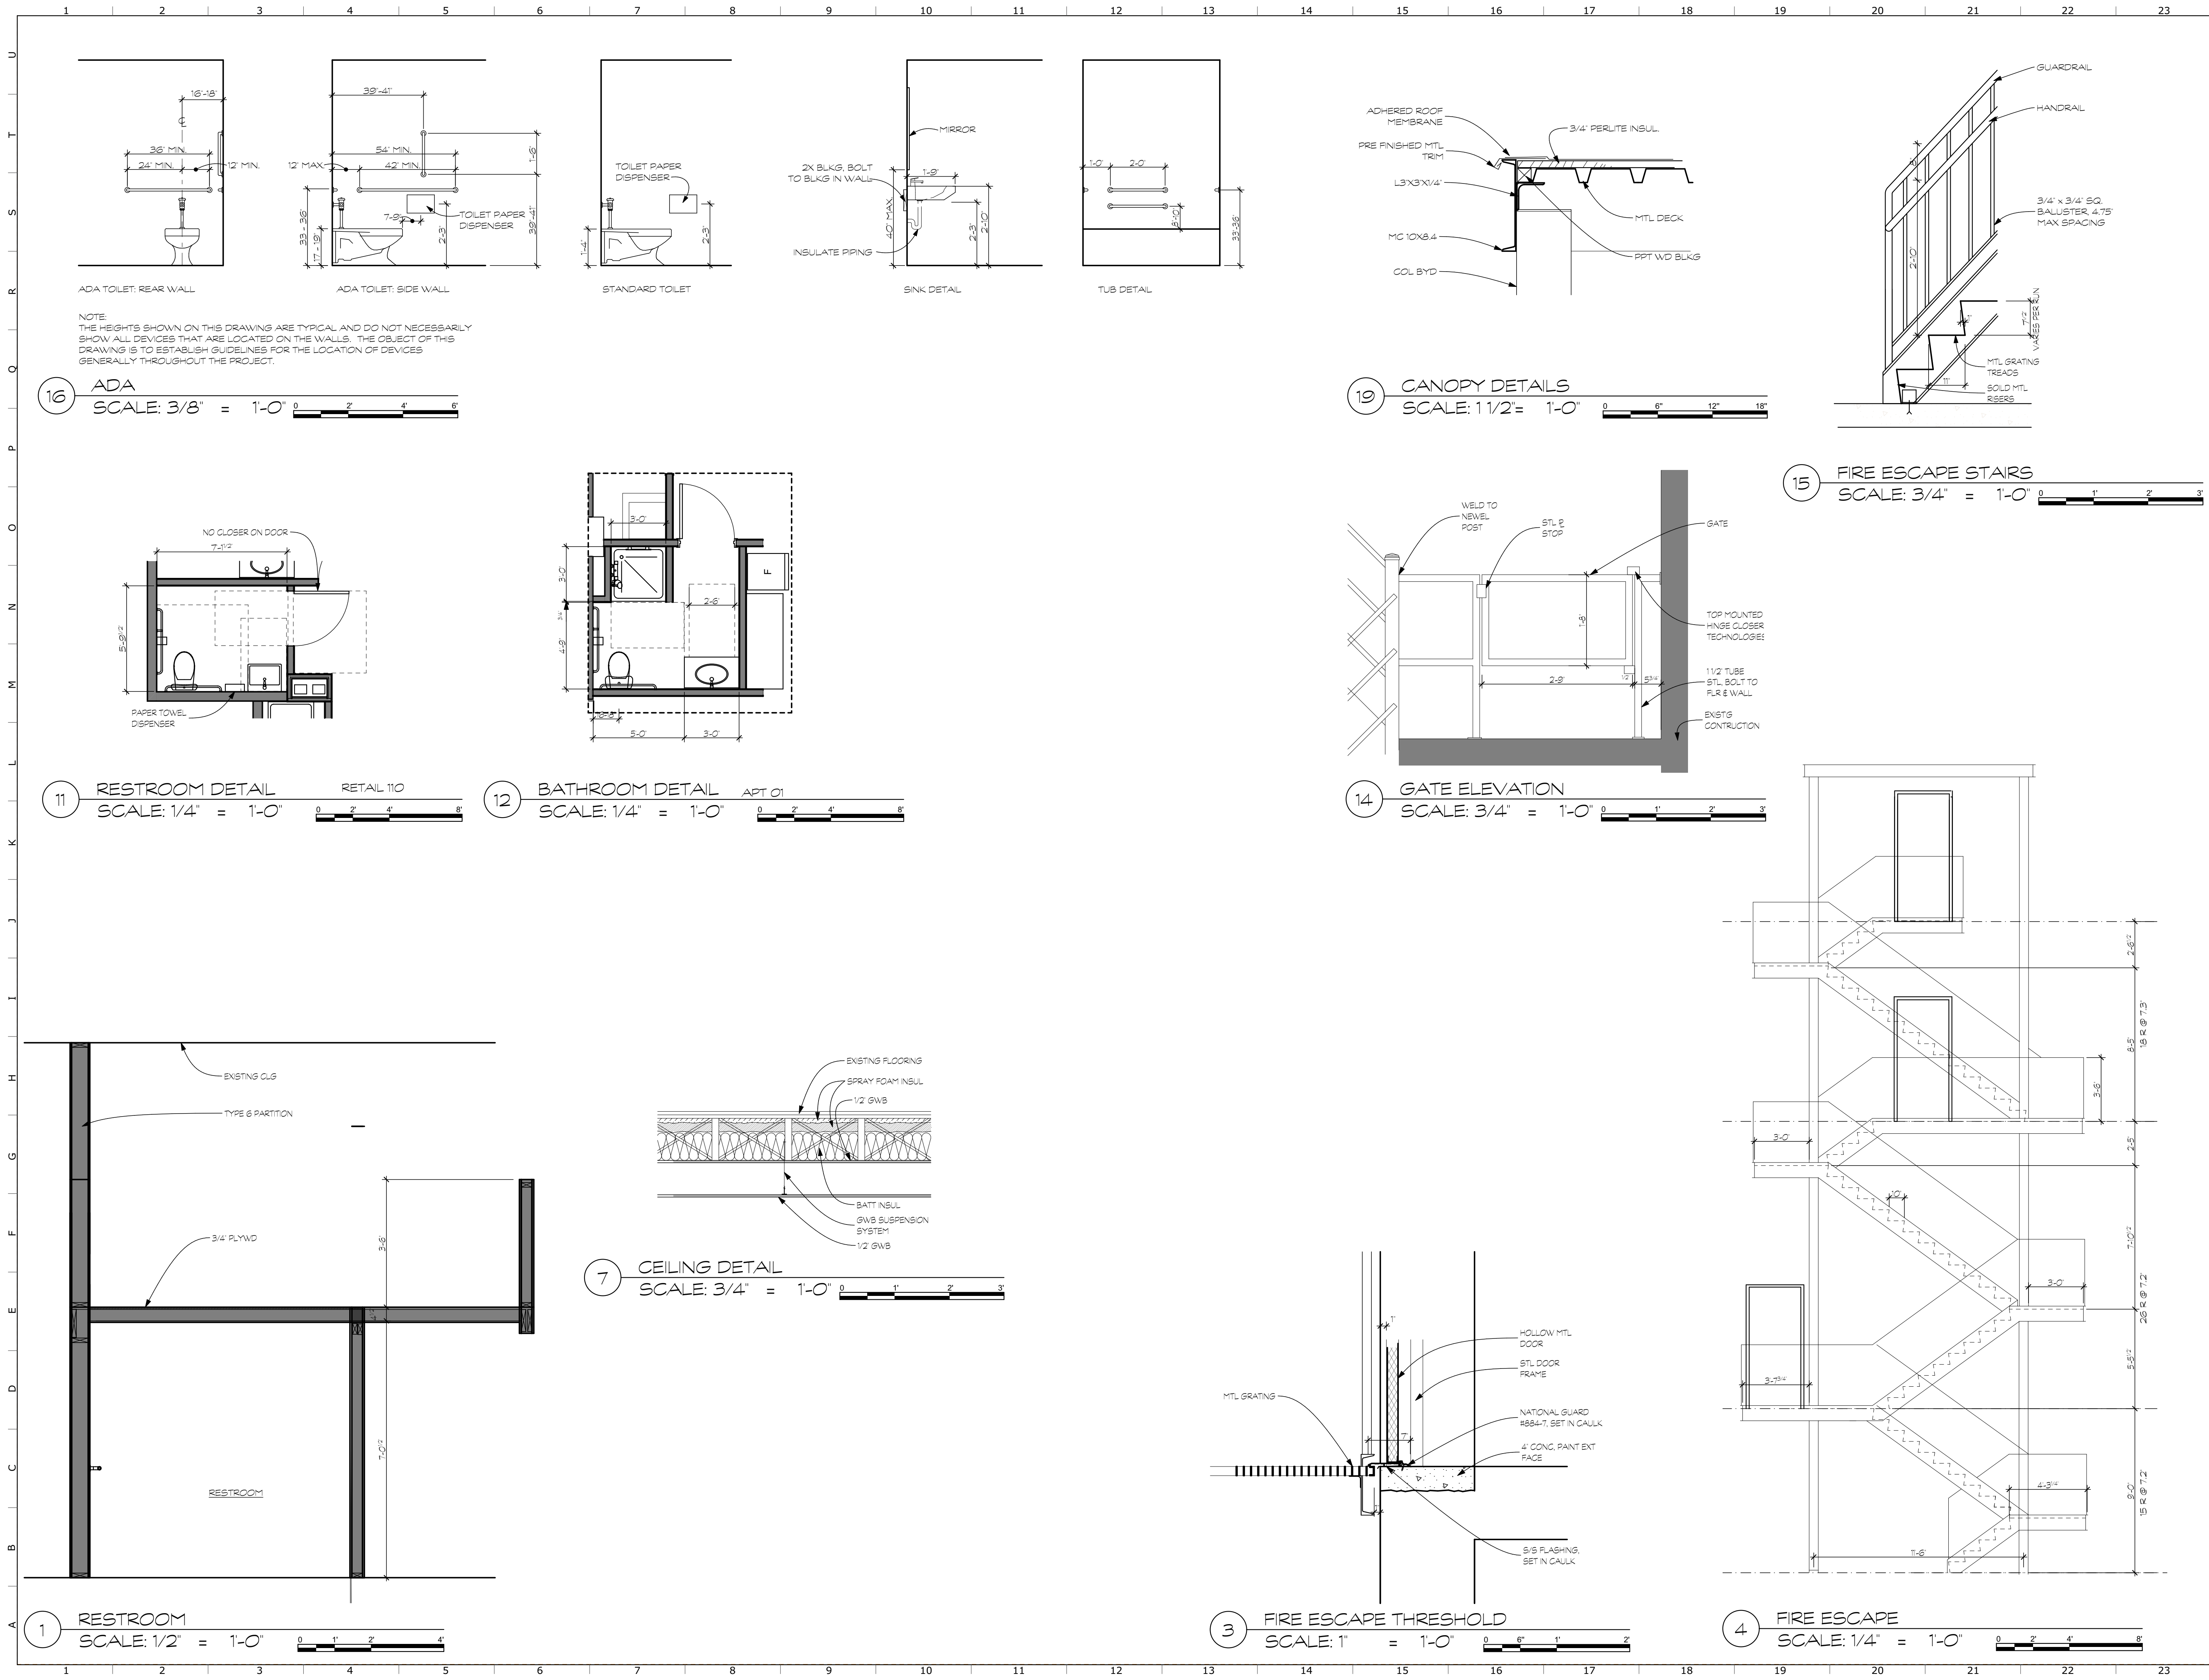
These plans have been approved by VDHR and NPS regarding historic tax credits and any changes made without prior review and approval by the architect and VDHR/NPS could endanger the owner's use of the credits.

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DATE	REVISION
3/9/21	REISSUED
3/26/21	REISSUED
	
PROJECT NUMBER:	SCALE:
2017.0086	AS NOTED
PROJECT MANAGER:	CHECKED BY:
DRAWN BY:	DATE:
	12/21/2020
DRAWING TITLE:	
WALL SECTIONS & DETAILS	
A3.1	
<small>These plans have been approved by VDHR and NPS regarding historic tax credits and any changes made without prior review and approval by the architect and VDHR/NPS could endanger the owner's use of the credits.</small>	

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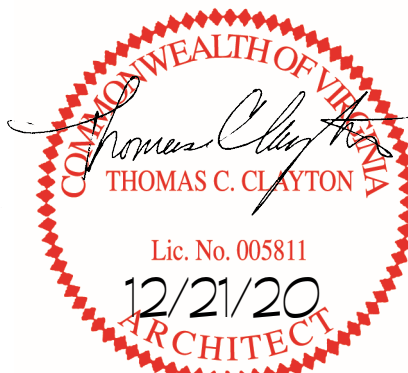
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KAVANAUGH BUILDING RENOVATIONS

HARRISONBURG, VIRGINIA

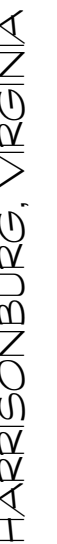
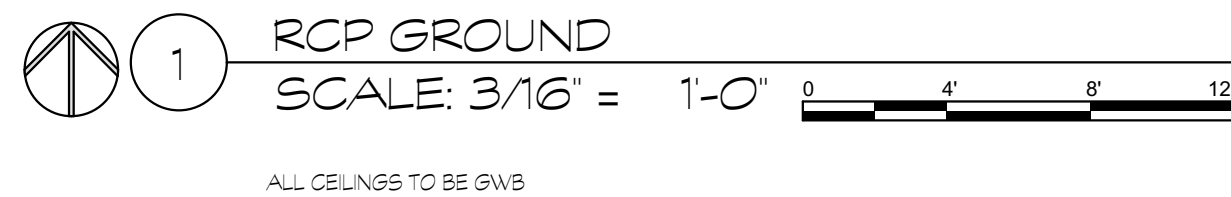
DATE	REVISION
2/10/2021	DETAIL 12
3/26/21	REISSUED



PROJECT NUMBER:	SCALE:
2017.0086	AS NOTED
PROJECT MANAGER:	CHECKED BY:
DRAWN BY:	DATE:
	12/21/2020
DRAWING TITLE:	
ENLARGED PLANS	

A4.1

These plans have been approved by VDHR and NPS regarding historic tax credits and any changes made without prior review and approval by the architect and VDHR/NPS could endanger the owner's use of the credits.

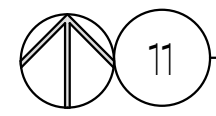


COMMONWEALTH OF VIRGINIA
Thomas C. Clayton
 THOMAS C. CLAYTON
 Lic. No. 005811
 12/21/20
 ARCHITECT

DRAWING TITLE:
REFLECTED CEILING PLAN -
BASEMENT

These plans have been approved by VDHR and NPS regarding historic tax credits and any changes made without prior review and approval by the architect and VDHR/NPS could endanger the owner's use of the credits.

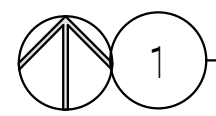
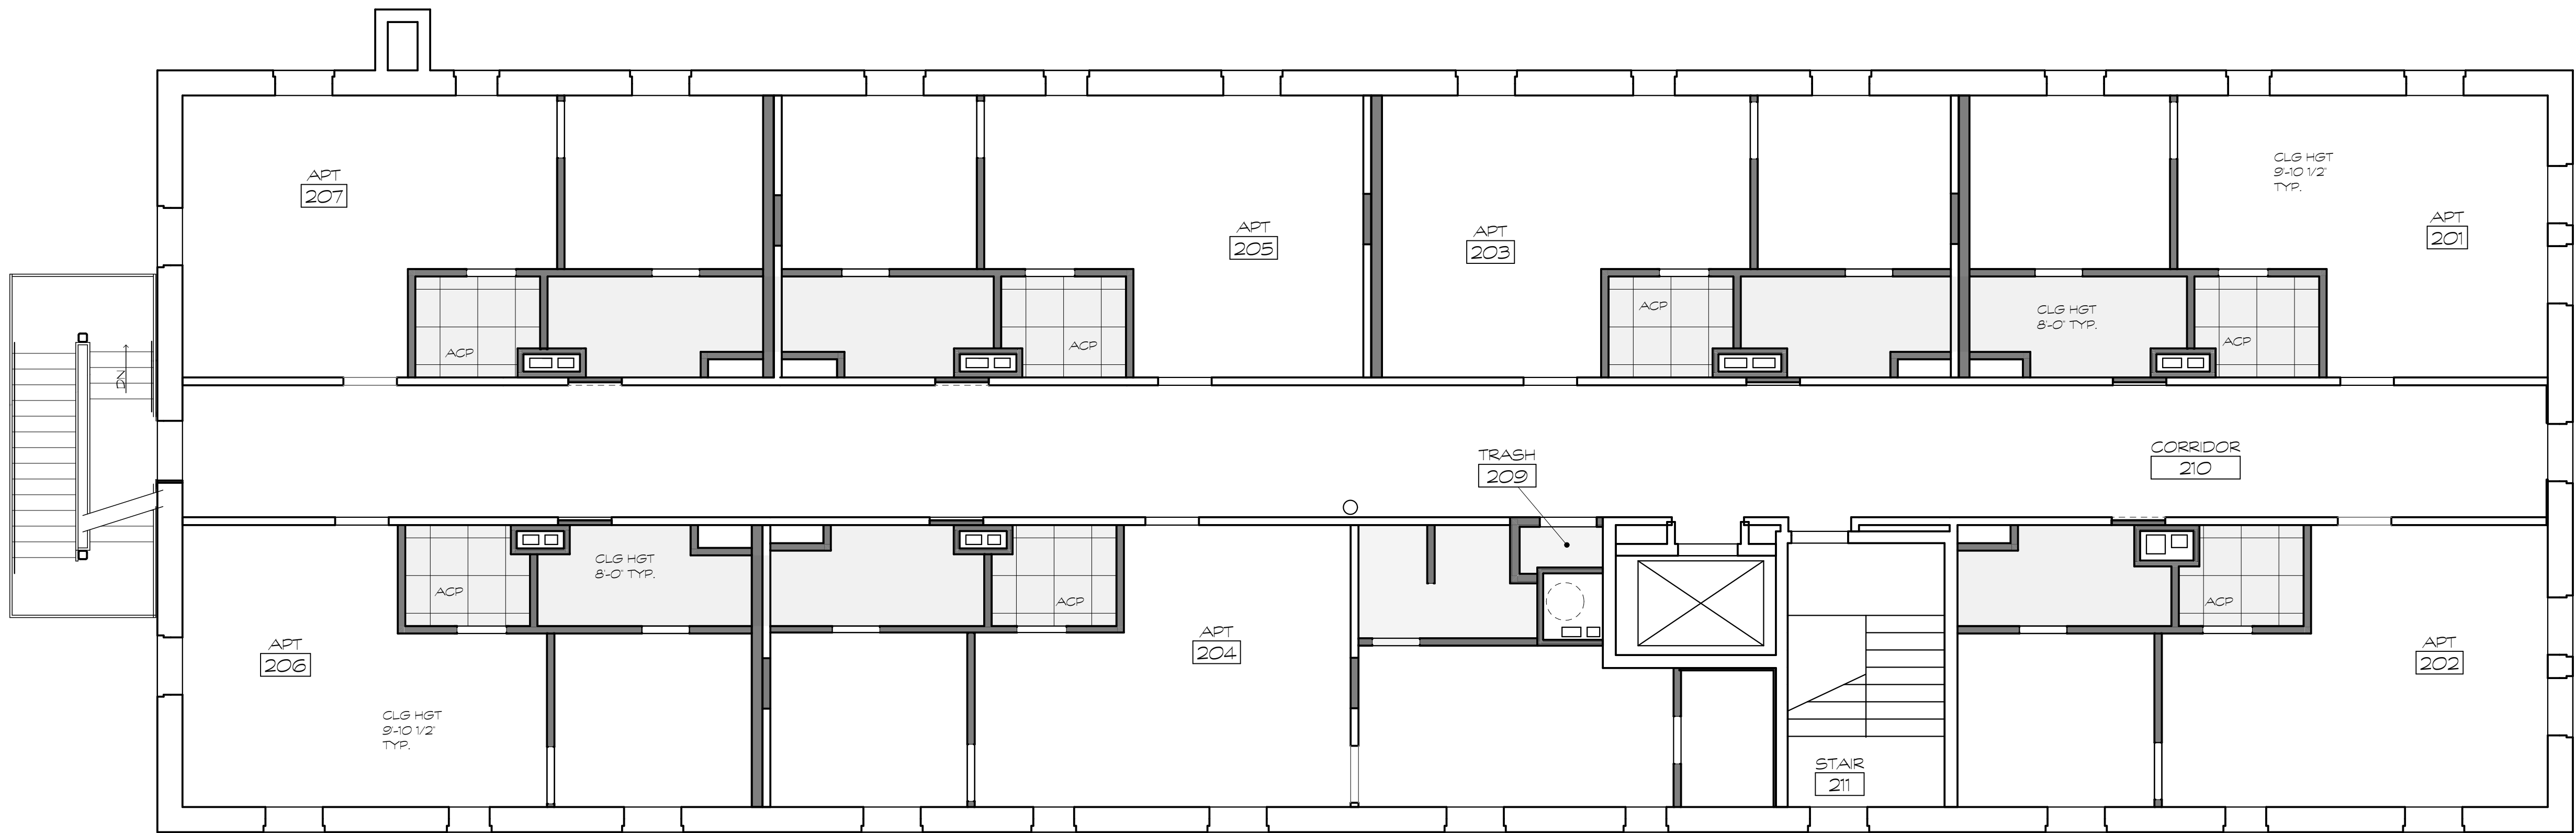
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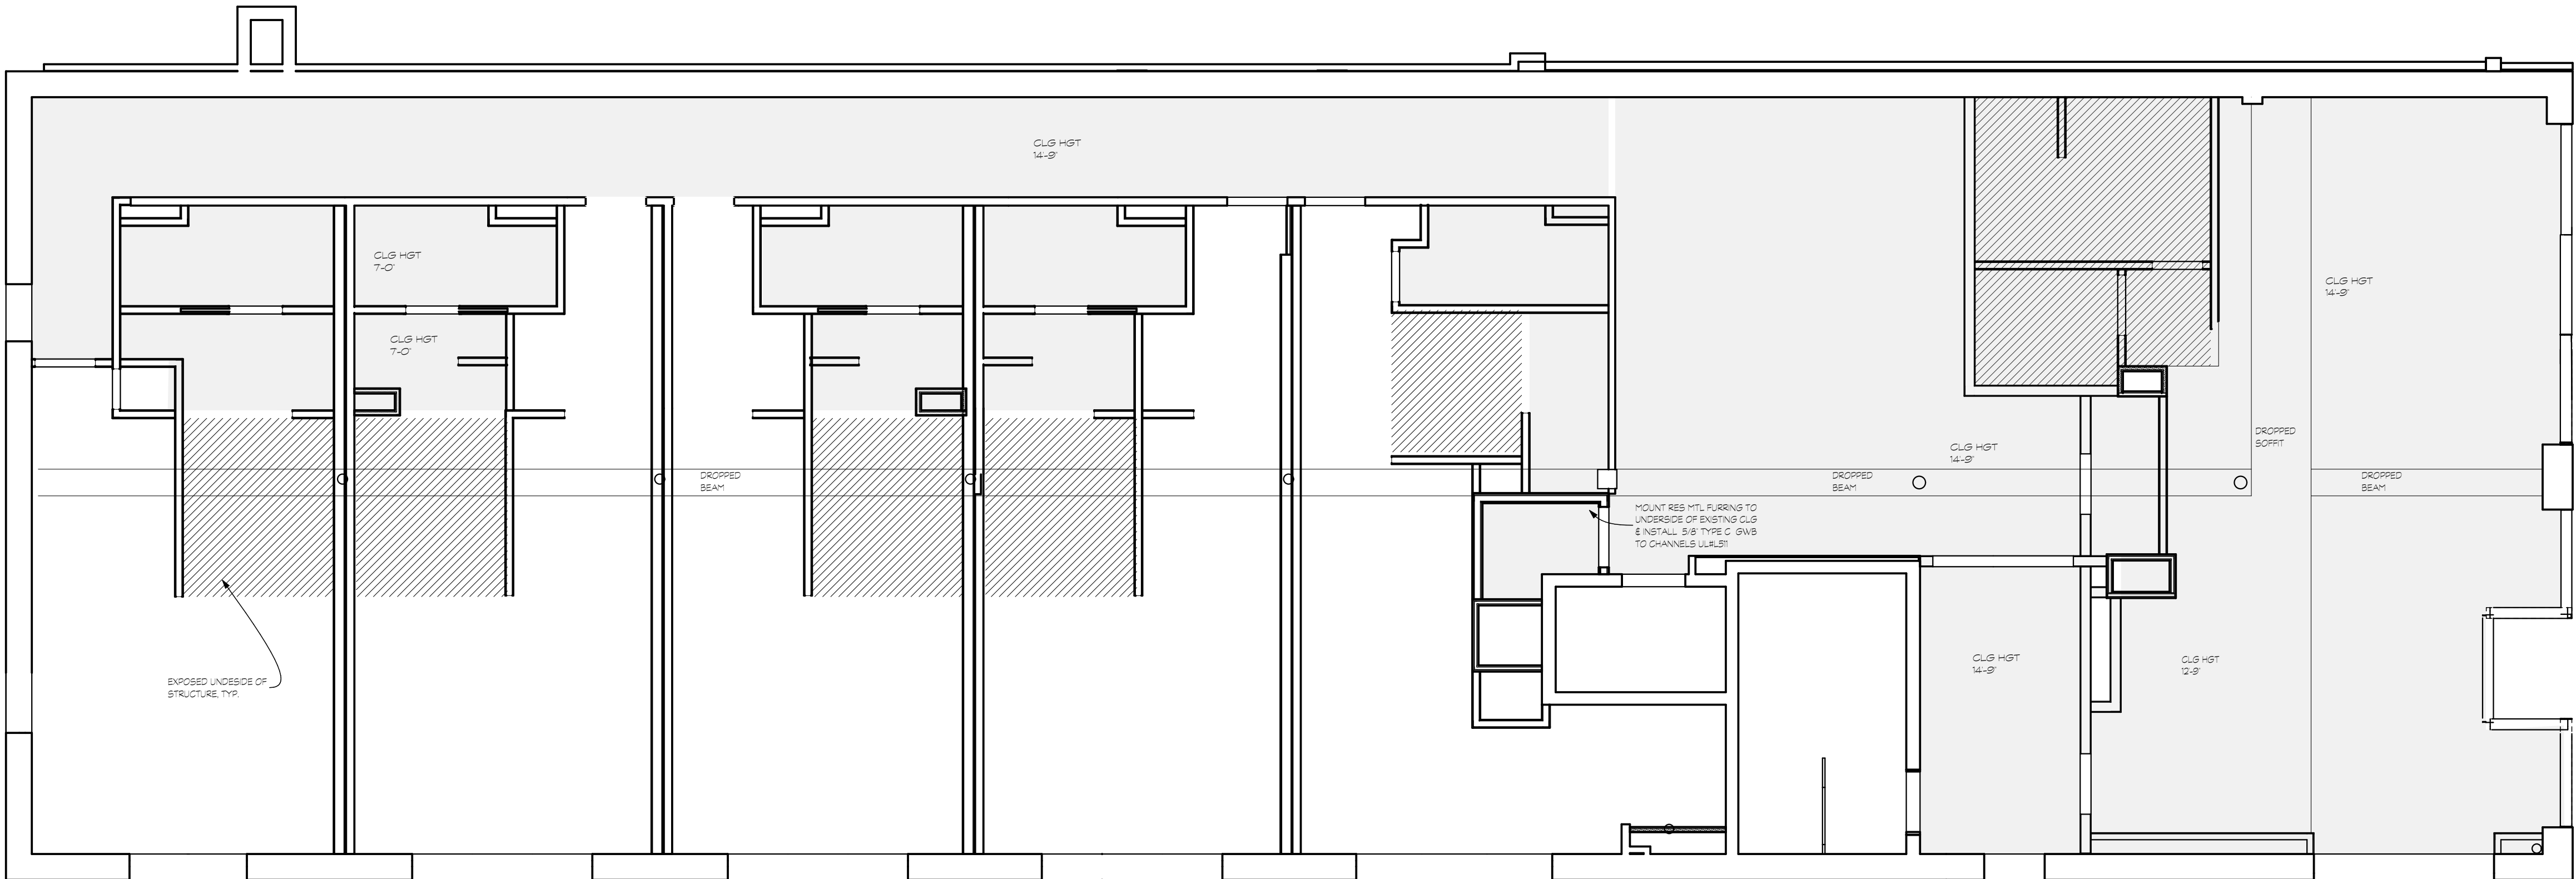
RCP SECOND FLOOR
SCALE: 3/16" = 1'-0" 0 4' 8' 12'

3RD FLR SIMILAR

ENTIRE FLOOR TO
HAVE GWS CEILINGS



1ST FLOOR CEILING PLAN
SCALE: 3/16" = 1'-0" 0 4' 8' 12'



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KAVANAUGH BUILDING RENOVATIONS

HARRISONBURG, VIRGINIA

DATE	REVISION
3/9/21	REISSUED
3/26/21	REISSUED



PROJECT NUMBER: 2017.0086	SCALE: AS NOTED
PROJECT MANAGER:	CHECKED BY:
DRAWN BY:	DATE: 12/21/2020

DRAWING TITLE:
REFLECTED CEILING PLAN -
FIRST FLOOR

A7.1

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